



> architect: andrew goodwin, aia andrew@andrewgoodwin.us

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REVISIONS

REV # | REV DATE | REV DESCRIPTION 1 | 12/02/2021 | PC 1

ANDREW C. GOODWIN No. C-34213

PROJECT

BUCKLEY REMODEL 305 SHORT STREET ARROYO GRANDE, CA 93420

APN: 007-544-002 CLIENT

> RYAN BUCKLEY + BERENICE SAINT-SAENS 305 SHORT STREET ARROYO GRANDE, CA 93420

KEYNOTES: SITE

1. (E) CONCRETE DRIVEWAY PER PERMIT BLD21-000360 (ADU/GARAGE).

2. (N) TANKLESS WATER HEATER.

3. (E) WATER P.O.C. (3/4"). UPGRADE TO 1" METER. 4. (N) 100 AMP ELECTRICAL METER UPGRADE.

5. (E) ELECTRICAL PANEL LOCATION.

6. (N) SHUT OFF VALVE FOR METER IN YARD BOX.

7. DEMO (E) CONCRETE STEPS.

8. (E) TREE TO REMAIN.

9. CONCRETE WASHOUT.

10. (E) WASTE LINE TO SEWER. CONTRACTOR TO VERIFY.

11. (E) GAS METER LOCATION. COORDINATE WITH SOCAL GAS. SEE PERMIT BLD21-000360.

12. (N) SWALE TO COLLECT STORMWATER DRAINAGE. RE: DETAIL 24/A5.2.

13. (N) CONCRETE COVERED FRONT PATIO. LESS THAN 30" ABOVE GRADE.

JOB NUMBER: SHEET NUMBER

SHEET TITLE

TECHNICIAN:

A1.1

PROJECT MANAGER: BAS

EXISTING SITE PLAN

11/01/2021



(E) ADJACENT RESIDENCE (NOT IN SCOPE)

ÀPN: 007-544-010

(E) ADJACENT RESIDENCE (NOT IN SCOPE) APN: 007-544-011

PROPERTY LINE 135' - 6.5"

PROPERTY LINE 135' - 6.5"

(E) 2-CAR GARAGE AND ADU

NOT IN SCOPE

 $^{ imes}$ BLD21-000360 $^{ imes}$

FENCE LINE

SIDE SETBACK _____SIDE SETBACK

SLOPE

8 8

(E) ADJACENT RESIDENCE

(NOT IN SCOPE) APN: 007-544-003

ADDITION: 700 SF

(E) DRIVEWAY

FENCE LINE

(E) REMODEL 478 SF APN: 007-544-002

SIDE SETBACK

PROPERTY LINE 135' - 6.5"

(E) ADJACENT RESIDENCE (NOT IN SCOPE) APN: 007-544-012 KEYNOTES: SITE

1. (E) CONCRETE DRIVEWAY PER PERMIT BLD21-000360 (ADU/GARAGE).

2. (N) TANKLESS WATER HEATER.

3. (E) WATER P.O.C. (3/4"). UPGRADE TO 1" METER.

3. (L) WATER F.O.O. (3/4). OF GRADE TO FINITE

4. (N) 100 AMP ELECTRICAL METER UPGRADE.

5. (E) ELECTRICAL PANEL LOCATION.

6. (N) SHUT OFF VALVE FOR METER IN YARD BOX.

7. DEMO (E) CONCRETE STEPS.

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13. (N) CONCRETE COVERED FRONT PATIO. LESS THAN 30" ABOVE GRADE.

14. (N) ADDRESS NUMBERS.

AGD RCHITECTURE | DESIGN

ANDREW GOODWIN DESIGNS 2050 PARKER ST. SAN LUIS OBISPO, CA 93401 t: (805) 439-1611 www.andrewgoodwin.us

architect: andrew goodwin, aia andrew@andrewgoodwin.us

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1 | 12/02/2021 | PC 1

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ANDREW C.
GOODWIN

No. C-34213

REN. 10/31/2023

PROJECT

BUCKLEY REMODEL 305 SHORT STREET ARROYO GRANDE, CA 93420

APN: 007-544-002 **CLIENT**

RYAN BUCKLEY +
BERENICE
SAINT-SAENS
305 SHORT STREET
ARROYO GRANDE, CA
93420

SHEET TITLE

PROPOSED SITE PLAN

TECHNICIAN: BAS

01/10/2022

PROJECT MANAGER: BAS


JOB NUMBER:

SHEET NUMBER

A1.2

PROPOSED SITE PLAN

1" = 10'-0"

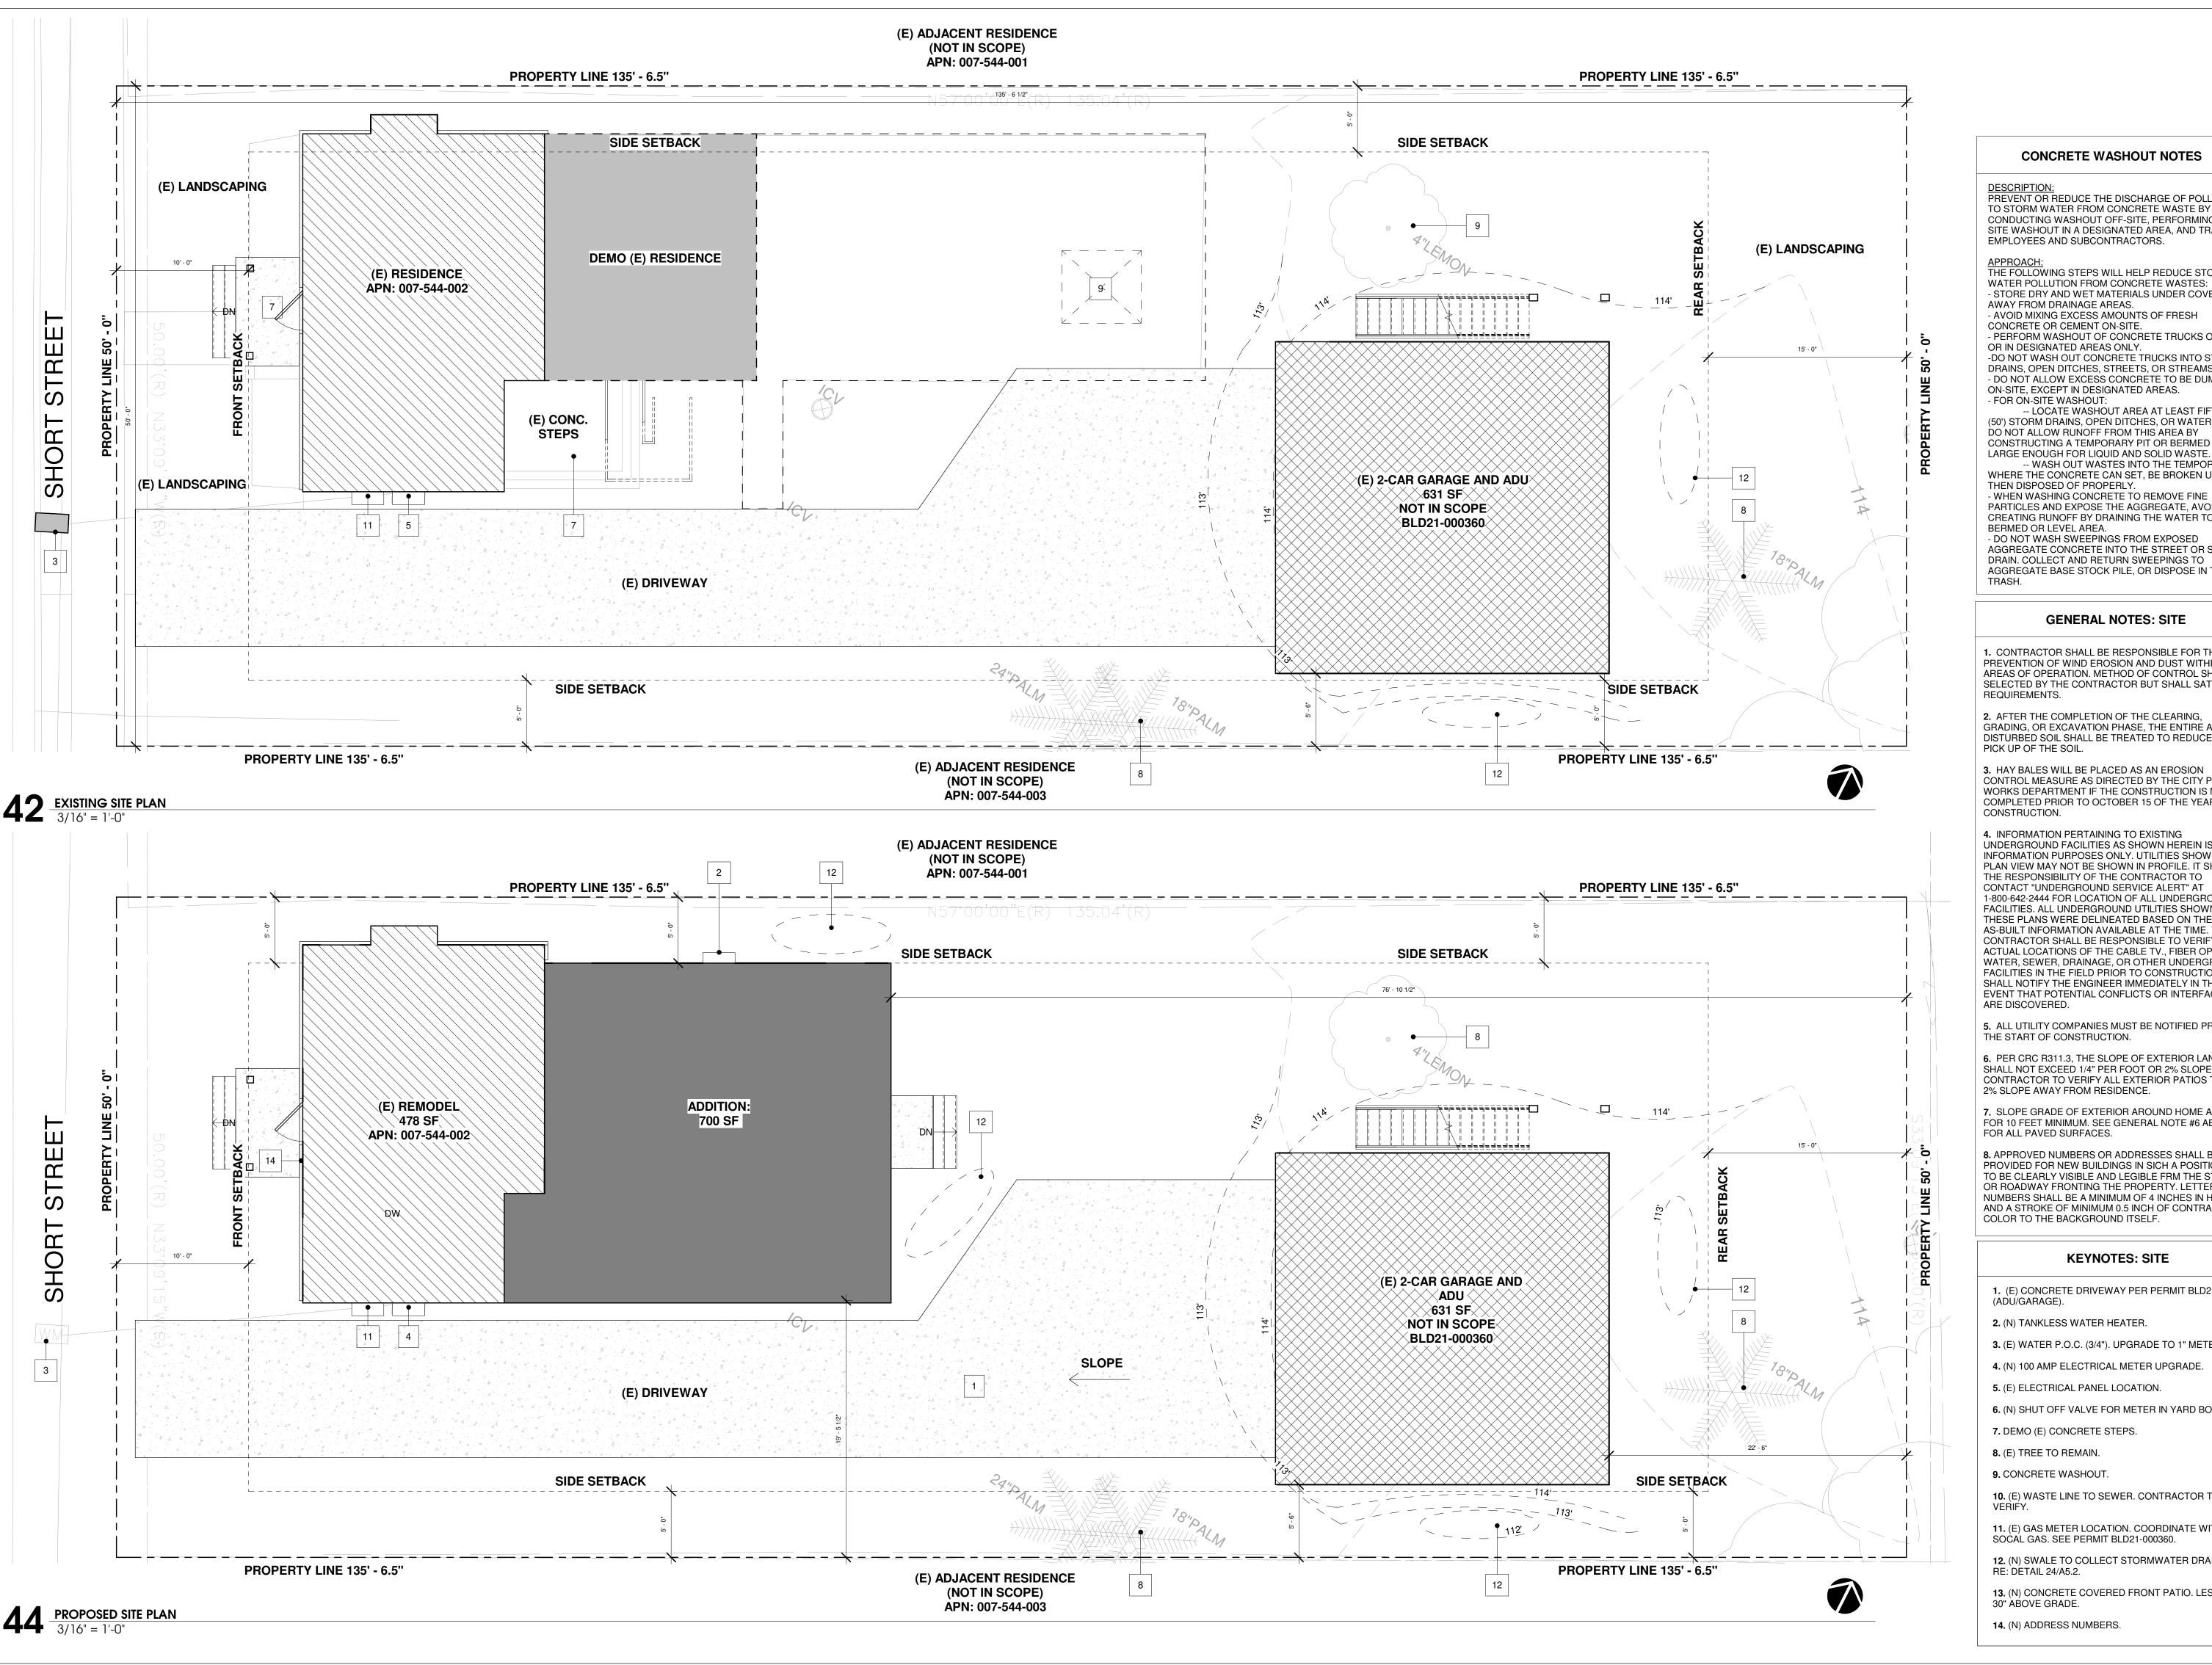



CONCRETE WASHOUT NOTES

PREVENT OR REDUCE THE DISCHARGE OF POLLUTANTS TO STORM WATER FROM CONCRETE WASTE BY CONDUCTING WASHOUT OFF-SITE, PERFORMING ON-SITE WASHOUT IN A DESIGNATED AREA, AND TRAINING EMPLOYEES AND SUBCONTRACTORS.

THE FOLLOWING STEPS WILL HELP REDUCE STORM WATER POLLUTION FROM CONCRETE WASTES: - STORE DRY AND WET MATERIALS UNDER COVER AWAY FROM DRAINAGE AREAS. - AVOID MIXING EXCESS AMOUNTS OF FRESH CONCRETE OR CEMENT ON-SITE. PERFORM WASHOUT OF CONCRETE TRUCKS OFF SITE OR IN DESIGNATED AREAS ONLY. -DO NOT WASH OUT CONCRETE TRUCKS INTO STORM DRAINS, OPEN DITCHES, STREETS, OR STREAMS. - DO NOT ALLOW EXCESS CONCRETE TO BE DUMPED

- FOR ON-SITE WASHOUT: -- LOCATE WASHOUT AREA AT LEAST FIFTY FEET (50') STORM DRAINS, OPEN DITCHES, OR WATER BODIES. DO NOT ALLOW RUNOFF FROM THIS AREA BY CONSTRUCTING A TEMPORARY PIT OR BERMED AREA

-- WASH OUT WASTES INTO THE TEMPORARY PIT

WHERE THE CONCRETE CAN SET, BE BROKEN UP, AND THEN DISPOSED OF PROPERLY. - WHEN WASHING CONCRETE TO REMOVE FINE PARTICLES AND EXPOSE THE AGGREGATE. AVOID CREATING RUNOFF BY DRAINING THE WATER TO BE BERMED OR LEVEL AREA. - DO NOT WASH SWEEPINGS FROM EXPOSED AGGREGATE CONCRETE INTO THE STREET OR STORM DRAIN. COLLECT AND RETURN SWEEPINGS TO AGGREGATE BASE STOCK PILE, OR DISPOSE IN THE

GENERAL NOTES: SITE

1. CONTRACTOR SHALL BE RESPONSIBLE FOR THE PREVENTION OF WIND EROSION AND DUST WITHIN THE AREAS OF OPERATION. METHOD OF CONTROL SHALL BE SELECTED BY THE CONTRACTOR BUT SHALL SATISFY REQUIREMENTS.

2. AFTER THE COMPLETION OF THE CLEARING, GRADING, OR EXCAVATION PHASE, THE ENTIRE AREA OF DISTURBED SOIL SHALL BE TREATED TO REDUCE WIND PICK UP OF THE SOIL.

3. HAY BALES WILL BE PLACED AS AN EROSION CONTROL MEASURE AS DIRECTED BY THE CITY PUBLIC WORKS DEPARTMENT IF THE CONSTRUCTION IS NOT COMPLETED PRIOR TO OCTOBER 15 OF THE YEAR OF CONSTRUCTION.

4. INFORMATION PERTAINING TO EXISTING UNDERGROUND FACILITIES AS SHOWN HEREIN IS FOR INFORMATION PURPOSES ONLY. UTILITIES SHOWN IN PLAN VIEW MAY NOT BE SHOWN IN PROFILE. IT SHALL BE THE RESPONSIBILITY OF THE CONTRACTOR TO CONTACT "UNDERGROUND SERVICE ALERT" AT 1-800-642-2444 FOR LOCATION OF ALL UNDERGROUND FACILITIES. ALL UNDERGROUND UTILITIES SHOWN ON THESE PLANS WERE DELINEATED BASED ON THE BEST AS-BUILT INFORMATION AVAILABLE AT THE TIME. THE CONTRACTOR SHALL BE RESPONSIBLE TO VERIFY THE ACTUAL LOCATIONS OF THE CABLE TV., FIBER OPTIC, WATER, SEWER, DRAINAGE, OR OTHER UNDERGROUND FACILITIES IN THE FIELD PRIOR TO CONSTRUCTION AND SHALL NOTIFY THE ENGINEER IMMEDIATELY IN THE EVENT THAT POTENTIAL CONFLICTS OR INTERFACES ARE DISCOVERED.

5. ALL UTILITY COMPANIES MUST BE NOTIFIED PRIOR TO THE START OF CONSTRUCTION.

6. PER CRC R311.3, THE SLOPE OF EXTERIOR LANDINGS SHALL NOT EXCEED 1/4" PER FOOT OR 2% SLOPE. CONTRACTOR TO VERIFY ALL EXTERIOR PATIOS TO BE 2% SLOPE AWAY FROM RESIDENCE.

7. SLOPE GRADE OF EXTERIOR AROUND HOME AT 5% FOR 10 FEET MINIMUM. SEE GENERAL NOTE #6 ABOVE FOR ALL PAVED SURFACES.

8. APPROVED NUMBERS OR ADDRESSES SHALL BE PROVIDED FOR NEW BUILDINGS IN SICH A POSITION AS TO BE CLEARLY VISIBLE AND LEGIBLE FRM THE STREET OR ROADWAY FRONTING THE PROPERTY. LETTERS OR NUMBERS SHALL BE A MINIMUM OF 4 INCHES IN HEIGHT AND A STROKE OF MINIMUM 0.5 INCH OF CONTRASTING COLOR TO THE BACKGROUND ITSELF.

KEYNOTES: SITE

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2. (N) TANKLESS WATER HEATER.

3. (E) WATER P.O.C. (3/4"). UPGRADE TO 1" METER.

4. (N) 100 AMP ELECTRICAL METER UPGRADE.

5. (E) ELECTRICAL PANEL LOCATION.

6. (N) SHUT OFF VALVE FOR METER IN YARD BOX.

7. DEMO (E) CONCRETE STEPS.

8. (E) TREE TO REMAIN.

9. CONCRETE WASHOUT.

10. (E) WASTE LINE TO SEWER. CONTRACTOR TO

11. (E) GAS METER LOCATION. COORDINATE WITH SOCAL GAS. SEE PERMIT BLD21-000360.

12. (N) SWALE TO COLLECT STORMWATER DRAINAGE.

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REVISIONS

REV # | REV DATE | REV DESCRIPTION

1 | 12/02/2021 | PC 1

SEAL ANDREW C. GOODWIN No. C-34213

PROJECT

CLIENT

BUCKLEY REMODEL 305 SHORT STREET ARROYO GRANDE, CA 93420

APN: 007-544-002

RYAN BUCKLEY + **BERENICE** SAINT-SAENS 305 SHORT STREET ARROYO GRANDE, CA 93420

SHEET TITLE

EXISTING AND PROPOSED

SITE PLAN


11/01/2021

TECHNICIAN:

PROJECT MANAGER: BAS

JOB NUMBER: SHEET NUMBER

A1.1

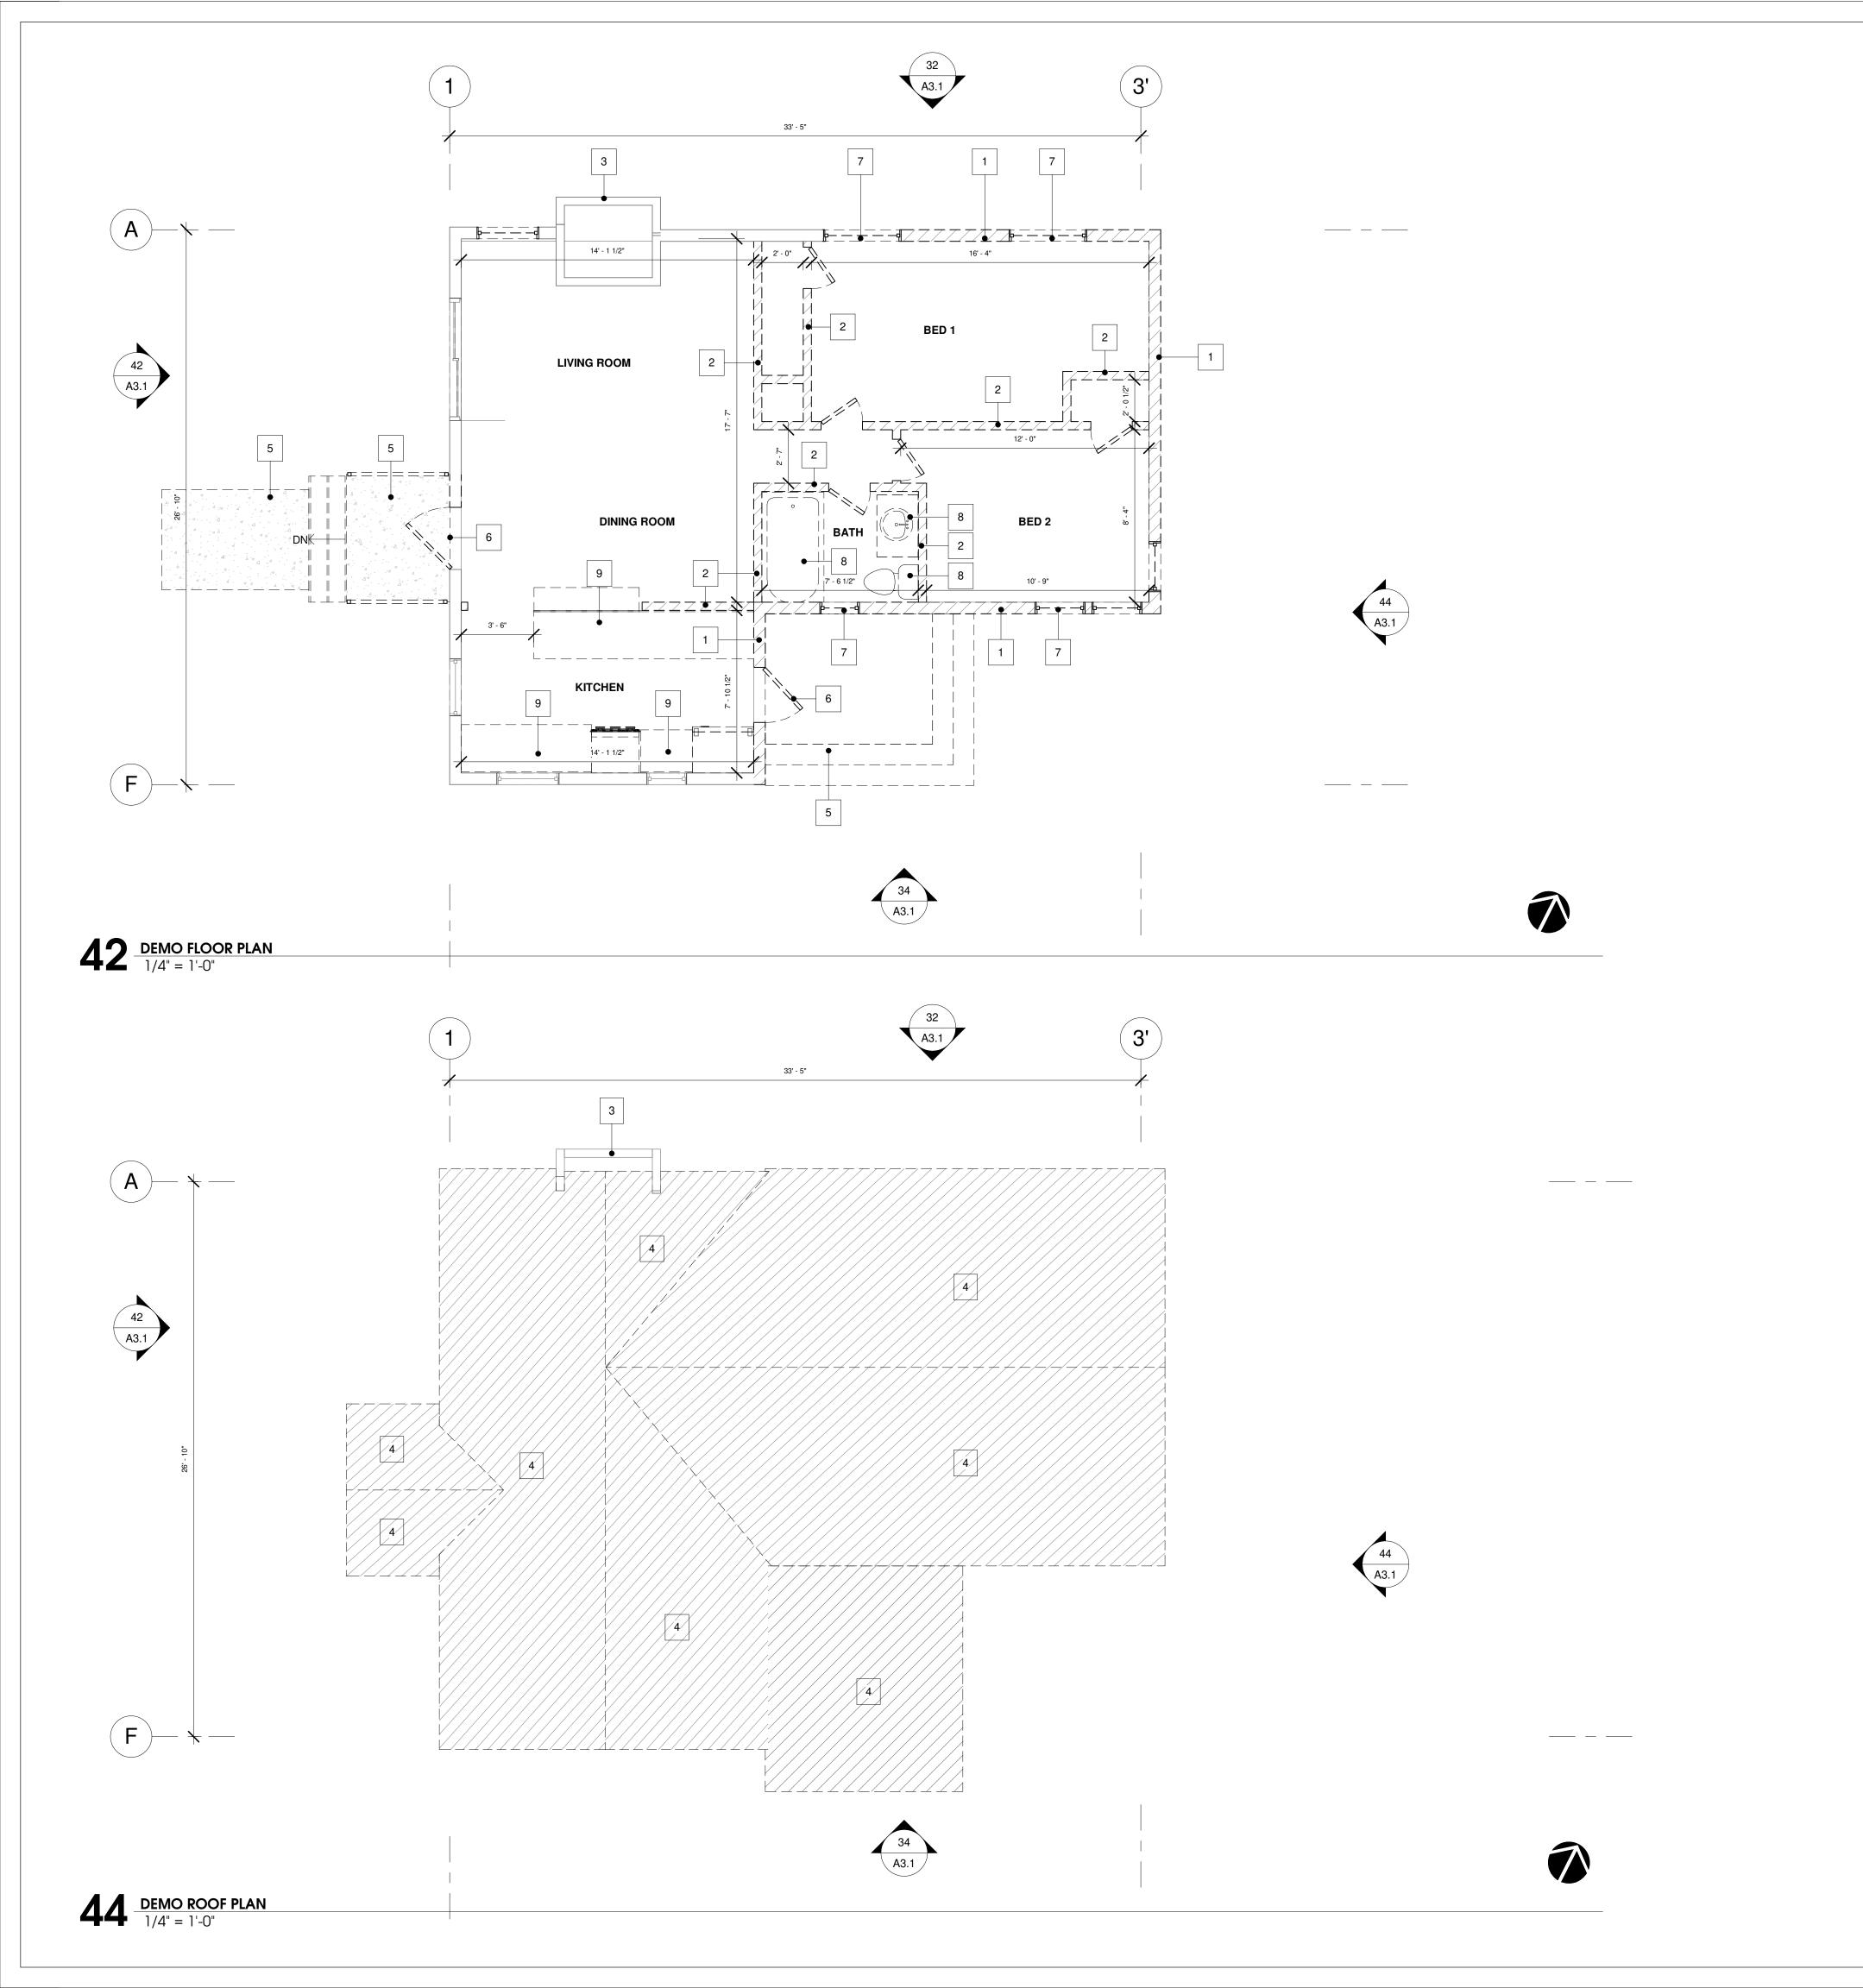



> architect: andrew goodwin, aia andrew@andrewgoodwin.us

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REVISIONS

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ANDREW C. GOODWIN No. C-34213

PROJECT

BUCKLEY REMODEL 305 SHORT STREET ARROYO GRANDE, CA

93420 APN: 007-544-002 CLIENT

> RYAN BUCKLEY + BERENICE SAINT-SAENS 305 SHORT STREET ARROYO GRANDE, CA 93420

GENERAL NOTES: DEMO FLOOR PLAN

1 - PROTECT EXISTING PORTIONS OF HOME NOT IN SCOPE OF WORK. CONTRACTOR TO NOTIFY ARCHITECT IF SCOPE CHANGES.

2- CONTRACTOR TO CONTACT ALL UTILITIES PRIOR TO DEMO. DISCONNECT OR TURN OFF UTILITIES AS

KEYNOTES: DEMO PLAN

1. REMOVE (E) EXTERIOR WALL.

2. REMOVE (E) INTERIOR WALL.

3. (E) FIREPLACE TO REMAIN. PROTECT FLUE.

4. REMOVE (E) ROOF.

5. REMOVE (E) CONCRETE STEPS.

6. REMOVE (E) EXTERIOR DOOR.

7. REMOVE (E) WINDOW.

8. REMOVE (E) PLUMBING FIXTURE.

9. REMOVE (E) COUNTER AND CABINETS BELOW.

LEGEND: DEMO PLAN

REMOVE WALL OR OBJECT.

SHEET TITLE **DEMO PLANS**

11/01/2021 DATE:

TECHNICIAN:

PROJECT MANAGER: BAS

JOB NUMBER:

SHEET NUMBER

A2.1


		Door Schedule										
Mark	Type Mark	Width	Height	Head Height	Frame Material	Door Material	Comments					
101A	Α	3' - 0"	6' - 8"	6' - 8"	WOOD	WOOD	EXTERIOR, CUSTOM					
101B	CC	3' - 0"	8' - 0"	8' - 0"								
105A	Α	2' - 6"	6' - 8"	6' - 8"	WOOD	COMPOSITE						
107A	С	3' - 0"	6' - 8"	6' - 8"	STEEL	STEEL						
108A	Α	2' - 6"	6' - 8"	6' - 8"	WOOD	COMPOSITE						
109A	Α	2' - 6"	6' - 8"	6' - 8"	WOOD	COMPOSITE						
109B	В	5' - 10"	6' - 8"	6' - 8"	WOOD	COMPOSITE						
110A	А	2' - 6"	6' - 8"	6' - 8"	WOOD	COMPOSITE						
110B	В	5' - 10"	6' - 8"	6' - 8"	WOOD	COMPOSITE						
201A	С	3' - 0"	6' - 8"	6' - 8"	STEEL	STEEL						
202A	А	2' - 6"	6' - 8"	6' - 8"	WOOD	COMPOSITE						
203A	Α	2' - 6"	6' - 8"	6' - 8"	WOOD	COMPOSITE						
204A	А	2' - 6"	6' - 8"	6' - 8"	WOOD	COMPOSITE						
205A	Α	2' - 6"	6' - 8"	6' - 8"	WOOD	COMPOSITE						

WOOD

COMPOSITE

Type Mark	Count	Width	Height	Head Height	Fire Rating	HEAT TRANSFER COEFFICIENT	SOLAR GAIN HEAT COEFFICIENT	Comments
			01 011		00.14111			I
Α	1	5' - 0"	3' - 0"	6' - 8"	20 MIN.	0.32	0.25	
В	6	3' - 0"	4' - 0"	6' - 8"	20 MIN.	0.32	0.25	
С	2	6' - 0"	4' - 0"	6' - 8"	20 MIN.	0.32	0.25	EGRESS WINDOW
D	6	2' - 8"	1' - 6"	6' - 8"	20 MIN.	0.32	0.25	TEMPERED
Е	1	6' - 0"	4' - 0"	6' - 8"	20 MIN.	0.32	0.25	TEMPERED
F	2	2' - 0"	3' - 6"	6' - 8"	20 MIN.	0.32	0.25	TEMPERED
G	2	4' - 0"	3' - 0"	6' - 8"	20 MIN.	0.32	0.25	

NOTE: CONTRACTOR TO SUBMIT WINDOWS FOR REVIEW BY ARCHITECT PRIOR TO ORDER.

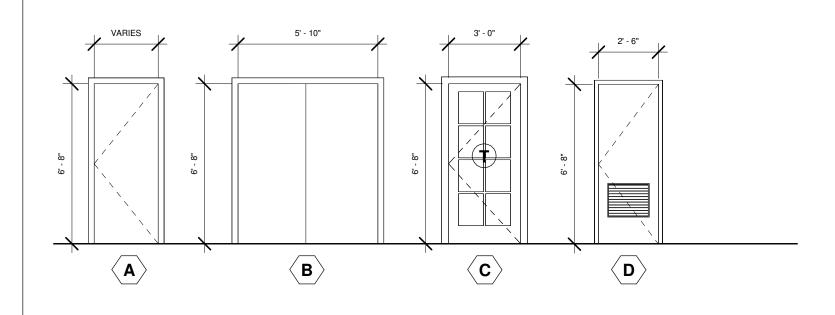


6' - 8"


6' - 8"

206A

HH

2' - 6"

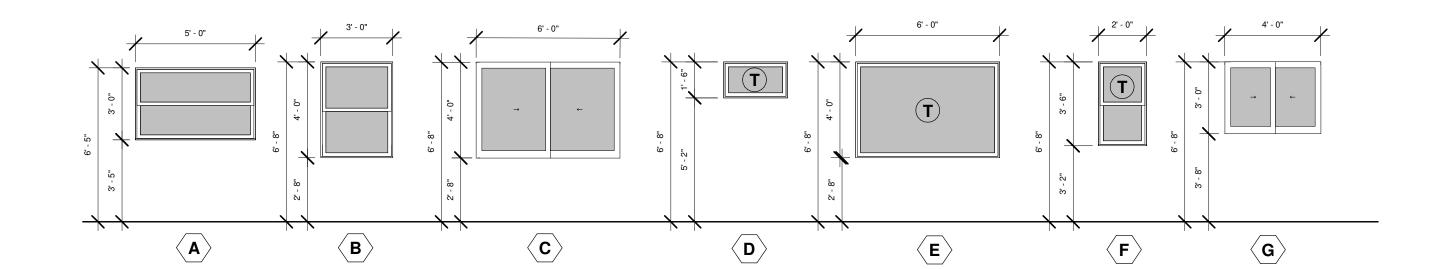

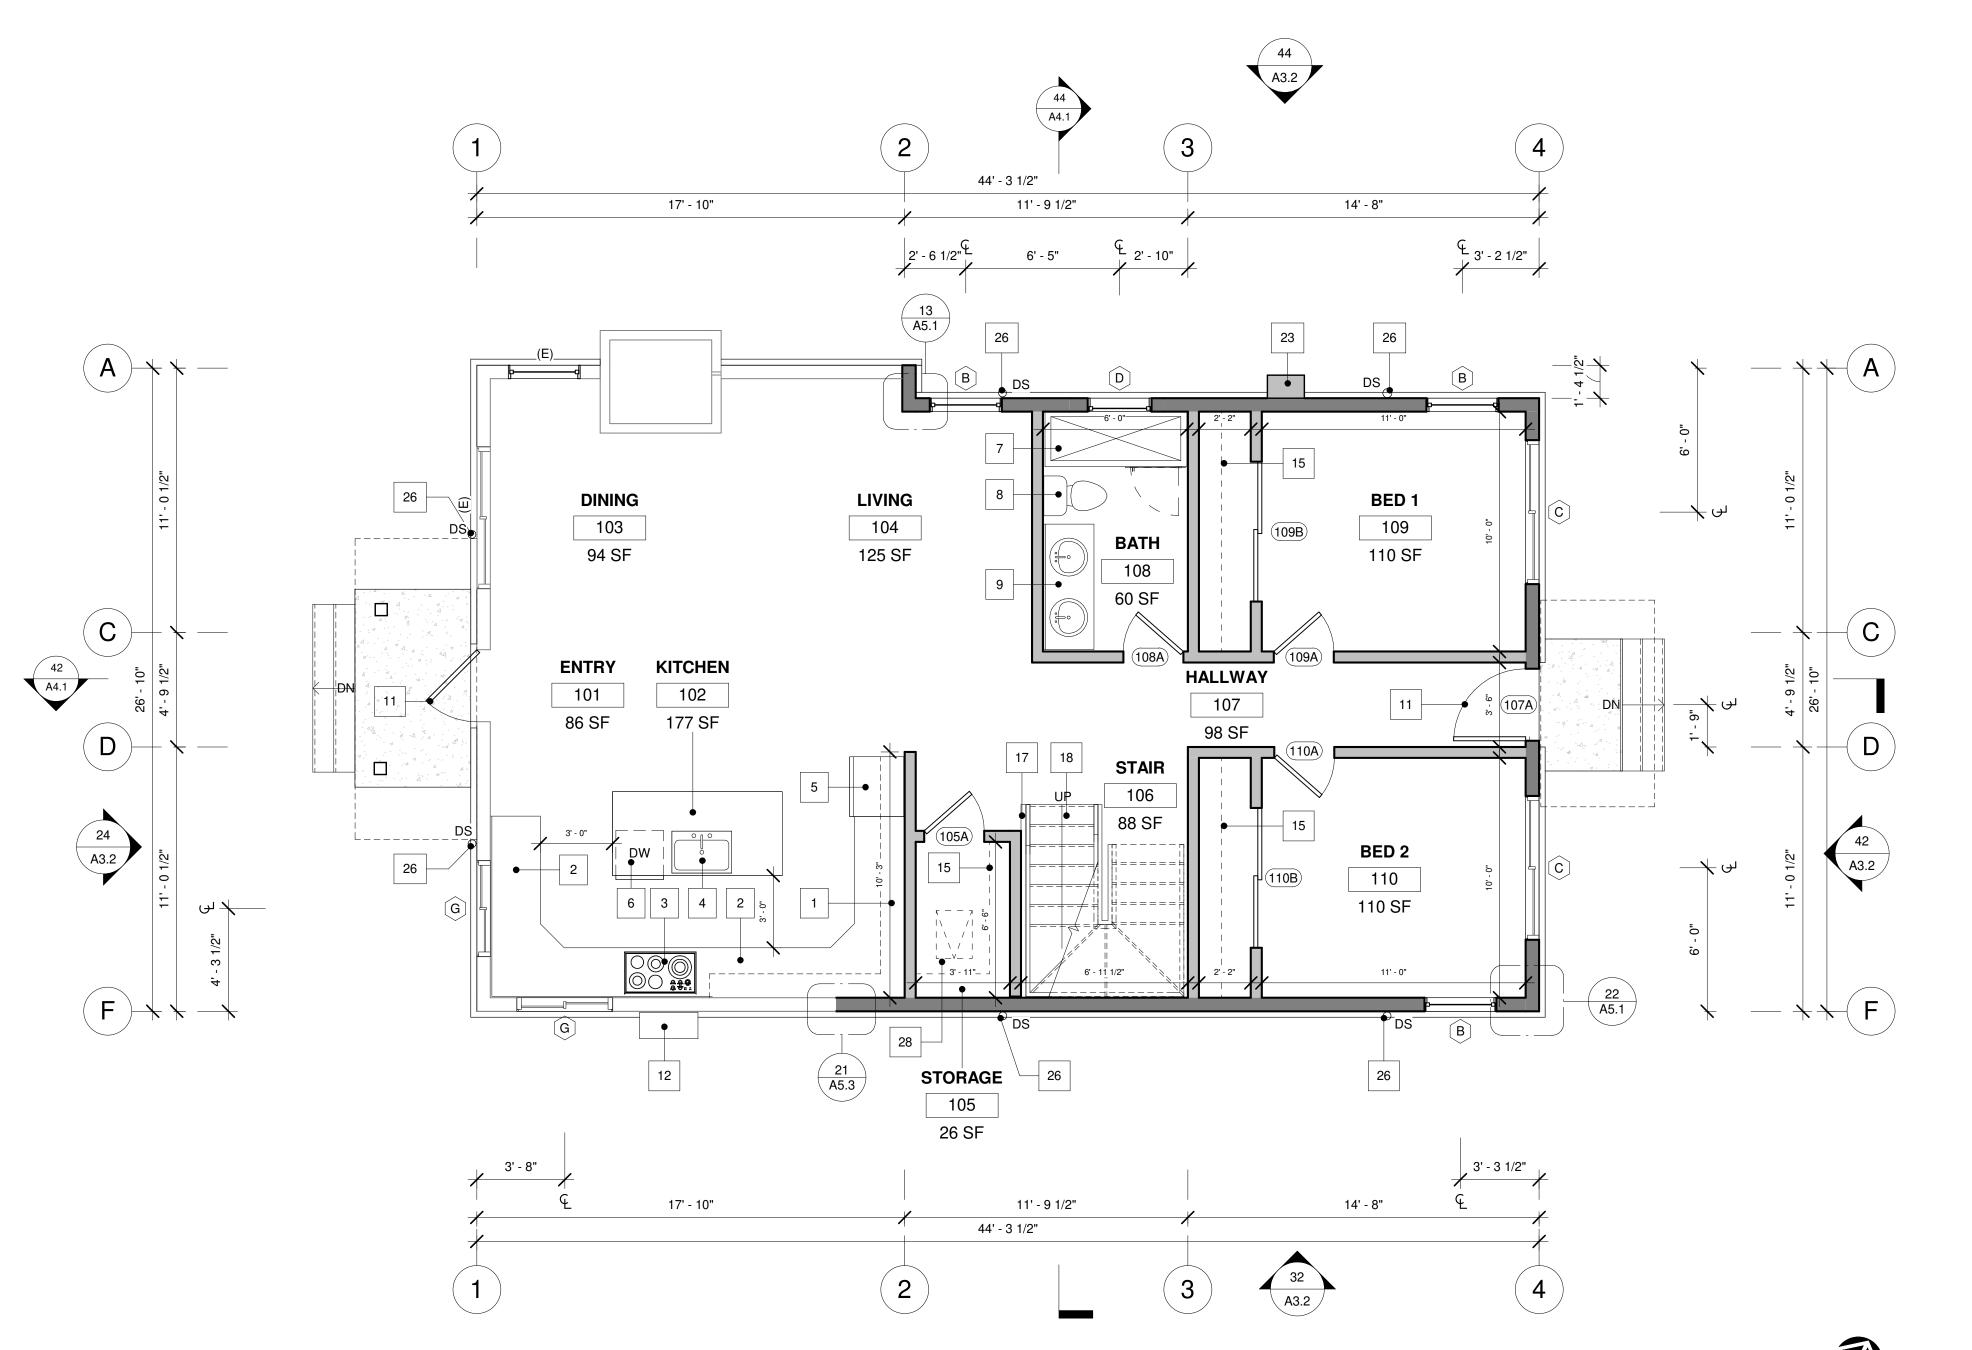

LEGEND: FLOOR PLANS (E) WALL TO REMAIN. (N) 2x4 WALL W/ R-13 SOUND BATT INSULATION. (N) 2X6 WALL W/ R-21 INSULATION (N) 42" H PONY WALL.

OBJECT/ROOF EDGE ABOVE

GENERAL NOTES: FLOOR PLAN

1 - FURNITURE IN PLAN IS ONLY DIAGRAMMATIC. NOT FOR CONSTRUCTION.

FIRE BLOCKING & DRAFT STOP NOTES

2 - WHERE REQUIRED, FIRE BLOCKING PER CRC R302.11 AND DRAFTSTOPS PER CRC R302.12 SHALL BE PROVIDED IN WOOD-FRAME CONSTRUCTION IN THE FOLLOWING LOCATIONS:

- IN CONCEALED SPACES OF STUD WALLS AND PARTITIONS, INCLUDING FURRED SPACES AND PARALLEL ROWS OF STUDS OR STAGGERED STUDS, AS FOLLOWS:

1.1. VERTICALLY AT THE CEILING AND FLOOR

1.1. VERTICALLY AT THE CEILING AND FLOOR LEVELS 1.2 HORIZONTALLY AT INTERVALS NOT EXCEEDING 10FT

- AT ALL INTERCONNECTIONS BETWEEN
CONCEALED VERTICAL AND HORIZONTAL
SPACES SUCH AS OCCUR AT SOFFITS, DROP
CEILINGS AND COVE CEILINGS.
- AT OPENINGS AROUND VENTS, PIPES, DUCTS,
CABLES AND WIRES AT CEILING AND FLOOR
LEVEL, WITH AN APPROVED MATERIAL TO RESIST
THE FREE PASSAGE OF FLAME AND PRODUCTS
OF COMBUSTION. THE MATERIAL FILLING THIS
ANNULAR SPACE SHALL NOT BE REQUIRED TO
MEET THE ASTM E 136 REQUIREMENTS.

3- SEE R302.11.1 FOR ACCEPTABLE FIRE BLOCKING MATERIALS.

4 - SEE R302.12.1 FOR ACCEPTABLE DRAFTSTOPPING MATERIALS.

5 - PROVIDE AT ALL OPENINGS AROUND GAS VENTS, PIPES, CHIMNEYS AND FIREPLACES AT THE CEILING SHALL BE FIRE BLOCKED WITH NON-COMBUSTIBLE MATERIALS.

6 - INTERIOR FINISHES TO BE COORDINATED BY OWNER AND INTERIOR DESIGNER.

7 - ENCLOSED FRAMING IN EXTERIOR BALCONIES AND ELEVATED WALKING SURFACES THAT ARE XPOSED TO RAIN, SNOW OR DRAINAGE FROM IRRIGATION SHALL BE PROVIDED WITH OPENIGNS THAT PROVIDE A NET-FREE CROSS VENTILATION AREA NOT LESS THAN 1/150 OF THE AREA OF EACH SEPARATE SPACE.

8 - TYPE I CLOTHES DRYER EXHAUST DUCTS SHALL BE OF RIGID METAL AND SHALL HAVE SMOOTH INTERIOR SURFACES. THE DIAMETER SHALL NOT BE LESS THAN 4" NOMINAL AND THE THICKNESS SHALL BE NOT LESS THAN 0.016 OF AN INCH.

KEYNOTES

1. (N) CABINETS ABOVE.

2. (N) SOLID SURFACE COUNTERTOP W/ CABINETS

3. (N) COOKTOP AND OVEN.

4. (N) GARBAGE DISPOSAL AND (N) SINK

5. (N) REFRIGERATOR.

6. (N) DISHWASHER.

7. (N) TUB OR SHOWER. OWNER TO VERIFY.

8. (N) 1.28 GPF TOILET.

9. (N) DOUBLE VANITY SINK PER CAL GREEN STANDARDS.

10. (N) EXTERIOR COMPOSITE DECK. AZEK DECKING, CLASS A, ESR-1667. INSTALL AZEK RAILING AT 42" H. GUARDRAIL TO RESIST LATERAL FORCE PER CRC R301.5. SLOPE 1/4" PER FOOT MIN..

11. (N) EXTERIOR DOOR W/ WEATHER STRIPPING AND THRESHOLD. RE: DOOR SCHEDULE.

12. (N) ELECTRIC METER.

13. (N) BATHTUB.

14. (N) 42" H GUARDRAIL AT DECK. RAILING TO RESIST 50 LBS OF LATERAL FORCE PER CRC. R301.5

15. (N) SHELF AND POLE ABOVE.

16. TILED SHOWER. INSTALL GLASS SPLASH GUARD WALL AND DOOR. OWNER TO VERIFY.

17. 36" HIGH HANDRAIL AT STAIR. RAILING TO RESIST 50 LBS OF LATERAL FORCE PER CRC R301.5.

18. (N) STAIRS. 7.5" RISE, 10" RUN.

19. (E) FIREPLACE. PROTECT.

20. (N) STACKED WASHER AND DRYER.

21. (N) LAUNDRY SINK.

22. (N) 42" H PONY WALL.

23. (N) TANKLESS WATER HEATER.

24. (N) ASPHALT COMP. SHINGLE ROOF O/ UNDERLAYMENT O/ ROOF SHEATHING PER MANUFACTURER'S RECOMMENDATION.

25. PRE-FINISHED GUTTER - K STYLE OR APPROVED EQUAL.

26. 3" DIA DOWNSPOUT W/ SPLASHBLOCKS.27. (N) ATTIC ACCESS HATCH.

28. (N) UNDER FLOOR ACCESS HATCH.

29. (N) LOUVER VENT DOOR.

30. (N) 1/16" METAL CONTINUOUS SOFFIT VENT AT BALCONIES. SEE 24/A5.3.

AGD

ARCHITECTURE | DESIGN

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1 12/02/2021 PC 1

SEAL



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BUCKLEY REMODEL 305 SHORT STREET ARROYO GRANDE, CA

APN: 007-544-002

93420

RYAN BUCKLEY +
BERENICE
SAINT-SAENS
305 SHORT STREET
ARROYO GRANDE, CA
93420

SHEET TITLE

PROPOSED FLOOR PLAN

THOI GOLD I LOOK! L

DATE: 11/01/2021

TECHNICIAN: B

PROJECT MANAGER: BAS

SHEET NUMBER

A2.2



> architect: andrew goodwin, aia andrew@andrewgoodwin.us

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305 SHORT STREET

ARROYO GRANDE, CA

93420

APN: 007-544-002

RYAN BUCKLEY +

BERENICE

SAINT-SAENS

305 SHORT STREET

ARROYO GRANDE, CA

93420

1 12/02/2021 PC 1 2 12/15/2021 PC 2

7 - ENCLOSED FRAMING IN EXTERIOR BALCONIES AND ELEVATED WALKING SURFACES THAT ARE XPOSED TO

PROJECT

CLIENT

CROSS VENTILATION AREA NOT LESS THAN 1/150 OF THE AREA OF EACH SEPARATE SPACE. 8 - TYPE I CLOTHES DRYER EXHAUST DUCTS SHALL BE SEAL OF RIGID METAL AND SHALL HAVE SMOOTH INTERIOR SURFACES. THE DIAMETER SHALL NOT BE LESS THAN 4" NOMINAL AND THE THICKNESS SHALL BE NOT LESS THAN 0.016 OF AN INCH.

KEYNOTES

GENERAL NOTES: FLOOR PLAN

1 - FURNITURE IN PLAN IS ONLY DIAGRAMMATIC. NOT

2 - WHERE REQUIRED, FIRE BLOCKING PER CRC R302.11

- IN CONCEALED SPACES OF STUD WALLS AND PARTITIONS, INCLUDING FURRED SPACES AND PARALLEL ROWS OF STUDS OR STAGGERED

1.1. VERTICALLY AT THE CEILING AND FLOOR

- AT OPENINGS AROUND VENTS, PIPES, DUCTS, CABLES AND WIRES AT CEILING AND FLOOR

LEVEL, WITH AN APPROVED MATERIAL TO RESIST

THE FREE PASSAGE OF FLAME AND PRODUCTS

OF COMBUSTION. THE MATERIAL FILLING THIS

MEET THE ASTM E 136 REQUIREMENTS.

3- SEE R302.11.1 FOR ACCEPTABLE FIRE BLOCKING

4 - SEE R302.12.1 FOR ACCEPTABLE DRAFTSTOPPING

5 - PROVIDE AT ALL OPENINGS AROUND GAS VENTS,

PIPES, CHIMNEYS AND FIREPLACES AT THE CEILING

SHALL BE FIRE BLOCKED WITH NON-COMBUSTIBLE

6 - INTERIOR FINISHES TO BE COORDINATED BY OWNER

RAIN, SNOW OR DRAINAGE FROM IRRIGATION SHALL BE PROVIDED WITH OPENIGNS THAT PROVIDE A NET-FREE

ANNULAR SPACE SHALL NOT BE REQUIRED TO

1.2 HORIZONTALLY AT INTERVALS NOT

CEILINGS AND COVE CEILINGS.

- AT ALL INTERCONNECTIONS BETWEEN CONCEALED VERTICAL AND HORIZONTAL SPACES SUCH AS OCCUR AT SOFFITS, DROP

FIRE BLOCKING & DRAFT STOP NOTES

STUDS, AS FOLLOWS:

EXCEEDING 10FT

AND DRAFTSTOPS PER CRC R302.12 SHALL BE PROVIDED IN WOOD-FRAME CONSTRUCTION IN THE

FOR CONSTRUCTION.

FOLLOWING LOCATIONS:

LEVELS

MATERIALS.

MATERIALS.

MATERIALS.

AND INTERIOR DESIGNER.

1. (N) CABINETS ABOVE.

2. (N) SOLID SURFACE COUNTERTOP W/ CABINETS

3. (N) COOKTOP AND OVEN.

4. (N) GARBAGE DISPOSAL AND (N) SINK

5. (N) REFRIGERATOR.

6. (N) DISHWASHER.

7. (N) TUB OR SHOWER. OWNER TO VERIFY.

8. (N) 1.28 GPF TOILET.

9. (N) DOUBLE VANITY SINK PER CAL GREEN STANDARDS.

10. (N) EXTERIOR COMPOSITE DECK. AZEK DECKING, CLASS A, ESR-1667. INSTALL AZEK RAILING AT 42" H. GUARDRAIL TO RESIST LATERAL FORCE PER CRC R301.5. SLOPE 1/4" PER FOOT MIN..

11. (N) EXTERIOR DOOR W/ WEATHER STRIPPING AND THRESHOLD. RE: DOOR SCHEDULE.

12. (N) ELECTRIC METER.

13. (N) BATHTUB.

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15. (N) SHELF AND POLE ABOVE.

16. TILED SHOWER. INSTALL GLASS SPLASH GUARD WALL AND DOOR. OWNER TO VERIFY.

17. 36" HIGH HANDRAIL AT STAIR. RAILING TO RESIST 50 LBS OF LATERAL FORCE PER CRC R301.5.

18. (N) STAIRS. 7.5" RISE, 10" RUN.

19. (E) FIREPLACE. PROTECT.

20. (N) STACKED WASHER AND DRYER.

22. (N) 42" H PONY WALL.

24. (N) ASPHALT COMP. SHINGLE ROOF O/

26. 3" DIA DOWNSPOUT W/ SPLASHBLOCKS.

29. (N) LOUVER VENT DOOR.



(E) WALL TO REMAIN.

(N) 2x4 WALL W/ R-13 SOUND BATT INSULATION.

(N) 2X6 WALL W/ R-21 INSULATION

(N) 42" H PONY WALL.

OBJECT/ROOF EDGE ABOVE.

30. (N) 1/16" METAL CONTINUOUS SOFFIT VENT AT BALCONIES. SEE 24/A5.3.

PROPOSED SECOND FLOOR PLAN

1/4" = 1'-0"

A3.2

44' - 3 1/2"

TOILET

203

25 26

11' - 9 1/2"

44' - 3 1/2"

PRIMARY BED

LAUNDRY

206

4' - 0"

3' - 1"

11' - 9 1/2"

14' - 8"

CLOSET

204

CLOSET

205

25 24

14' - 8"

 (B)

A3.2

17' - 10"

24

6:12

17' - 10"

24

24

2

24

6:12

24

25

21. (N) LAUNDRY SINK.

23. (N) TANKLESS WATER HEATER.

UNDERLAYMENT O/ ROOF SHEATHING PER MANUFACTURER'S RECOMMENDATION.

25. PRE-FINISHED GUTTER - K STYLE OR APPROVED EQUAL.

27. (N) ATTIC ACCESS HATCH.

28. (N) UNDER FLOOR ACCESS HATCH.


SHEET TITLE

PROPOSED SECOND FLOOR PLAN

11/01/2021

TECHNICIAN: PROJECT MANAGER: BAS

JOB NUMBER: SHEET NUMBER A2.3

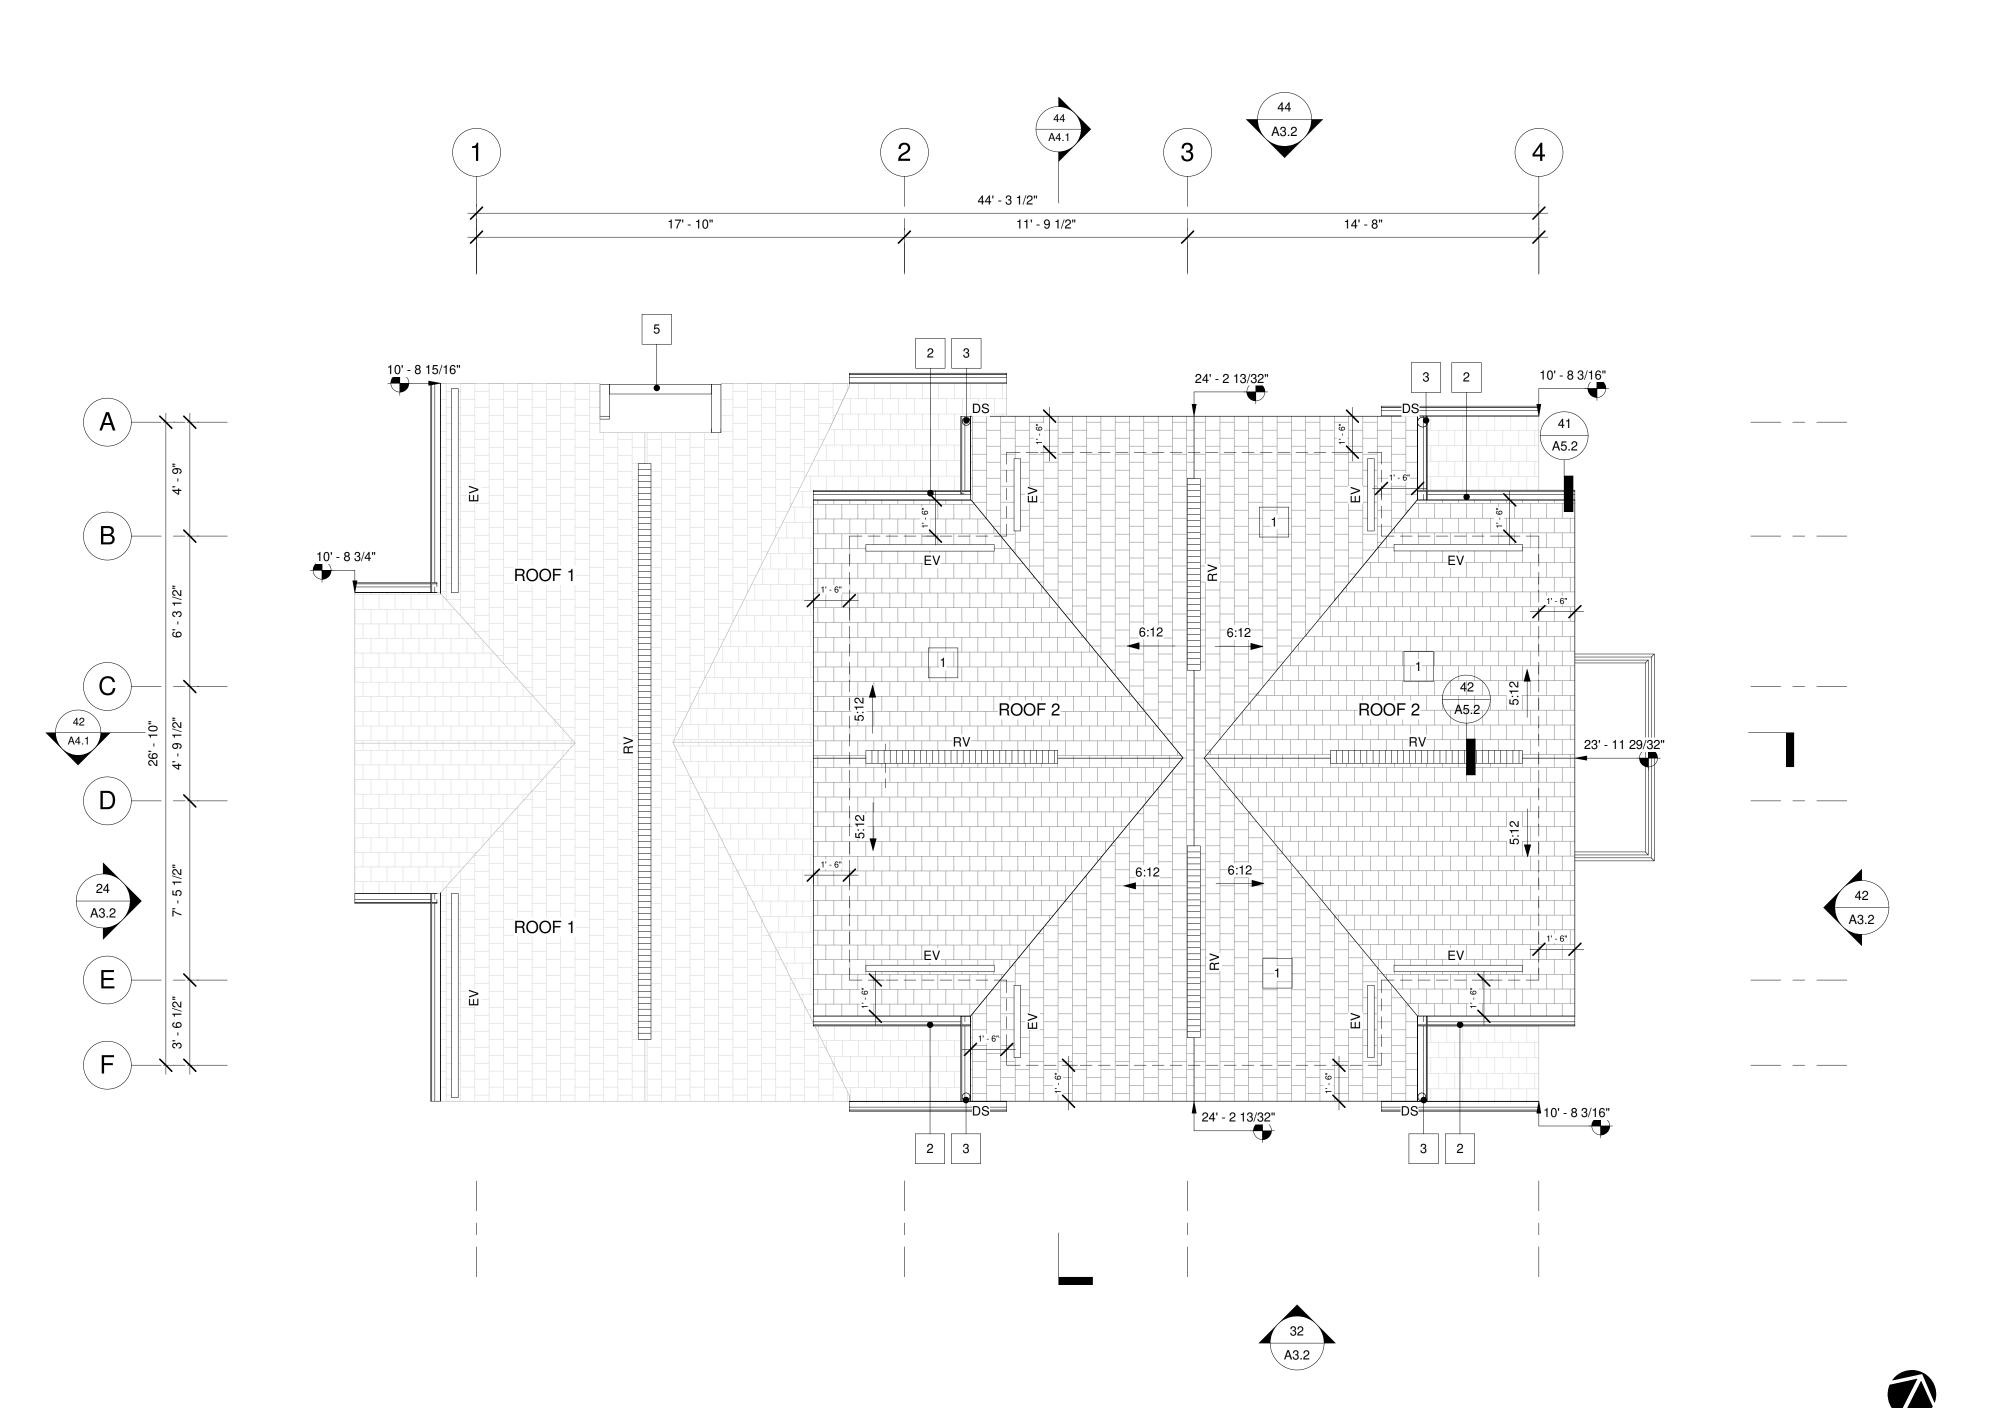

VENTILATION CALCULATIONS

ATTIC 1:

466 SF / 150 = 3.1 446 SQ. INCHES NFA REQ'D.

INSTALL RIDGE VENT, GAF COBRA RIGID VENT 2. NFA 18 SQ. IN./FT. @ 24' = 432 SQ. IN. NFA

INSTALL SOFFIT / EAVE VENT, 2" ROUND VENTS. RS-100 2".
1.846 SQ. IN. NFA EACH
@ 14 VENTS = 457 SQ. IN. NFA

ATTIC 2:

641 SF / 150 = 4.27 614 SQ. INCHES NFA REQ'D. INSTALL RIDGE VENTS, GAF COBRA RIGID VENT 2. NFA 18 SQ. IN./FT @ 32' = 576 SQ. IN. NFA

INSTALL SOFFIT / EAVE VENT, 2" ROUND VENTS. RS-100 2".
@ 42 VENTS = 8.86 SQ. IN. NFA

TOTAL: 664.6 SQ. IN. NFA

RV ||||||||| EV

☐ RIDGE VENT☐ EAVE VENT

KEYNOTES: ROOF

1. (N) ASPHALT COMP. SHINGLE ROOF O/ UNDERLAYMENT O/ ROOF SHEATHING PER MANUFACTURER'S RECOMMENDATION.

2. PRE-FINISHED GUTTER - K STYLE OR APPROVED EQUAL.

3. 3" DIA DOWNSPOUT W/ SPLASHBLOCKS.

4. NOT USED.

5. (E) FIREPLACE. PROTECT.

LEGEND: ROOF PLAN

DS ———

DENOTES DOWNSPOUT LOCATION.

WALL OR OBJECT BELOW

(N) ROOF

AGD ARCHITECTURE | DESIGN

ANDREW GOODWIN DESIGNS 2050 PARKER ST. SAN LUIS OBISPO, CA 93401 t: (805) 439-1611 www.andrewgoodwin.us

architect: andrew goodwin, aia andrew@andrewgoodwin.us

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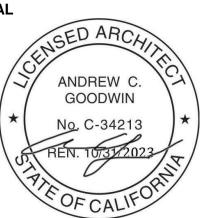
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REVISIONS

REV # | REV DATE | REV DESCRIPTION

1 | 12/02/2021 | PC 1

SEAL



PROJECT

BUCKLEY REMODEL 305 SHORT STREET ARROYO GRANDE, CA 93420

APN: 007-544-002 **CLIENT**

RYAN BUCKLEY +
BERENICE
SAINT-SAENS
305 SHORT STREET
ARROYO GRANDE, CA
93420

SHEET TITLE

PROPOSED ROOF PLAN

DATE:

TECHNICIAN:


11/01/2021

PROJECT MANAGER: BAS

JOB NUMBER:
SHEET NUMBER

A2.4

1/4" = 1'-0"

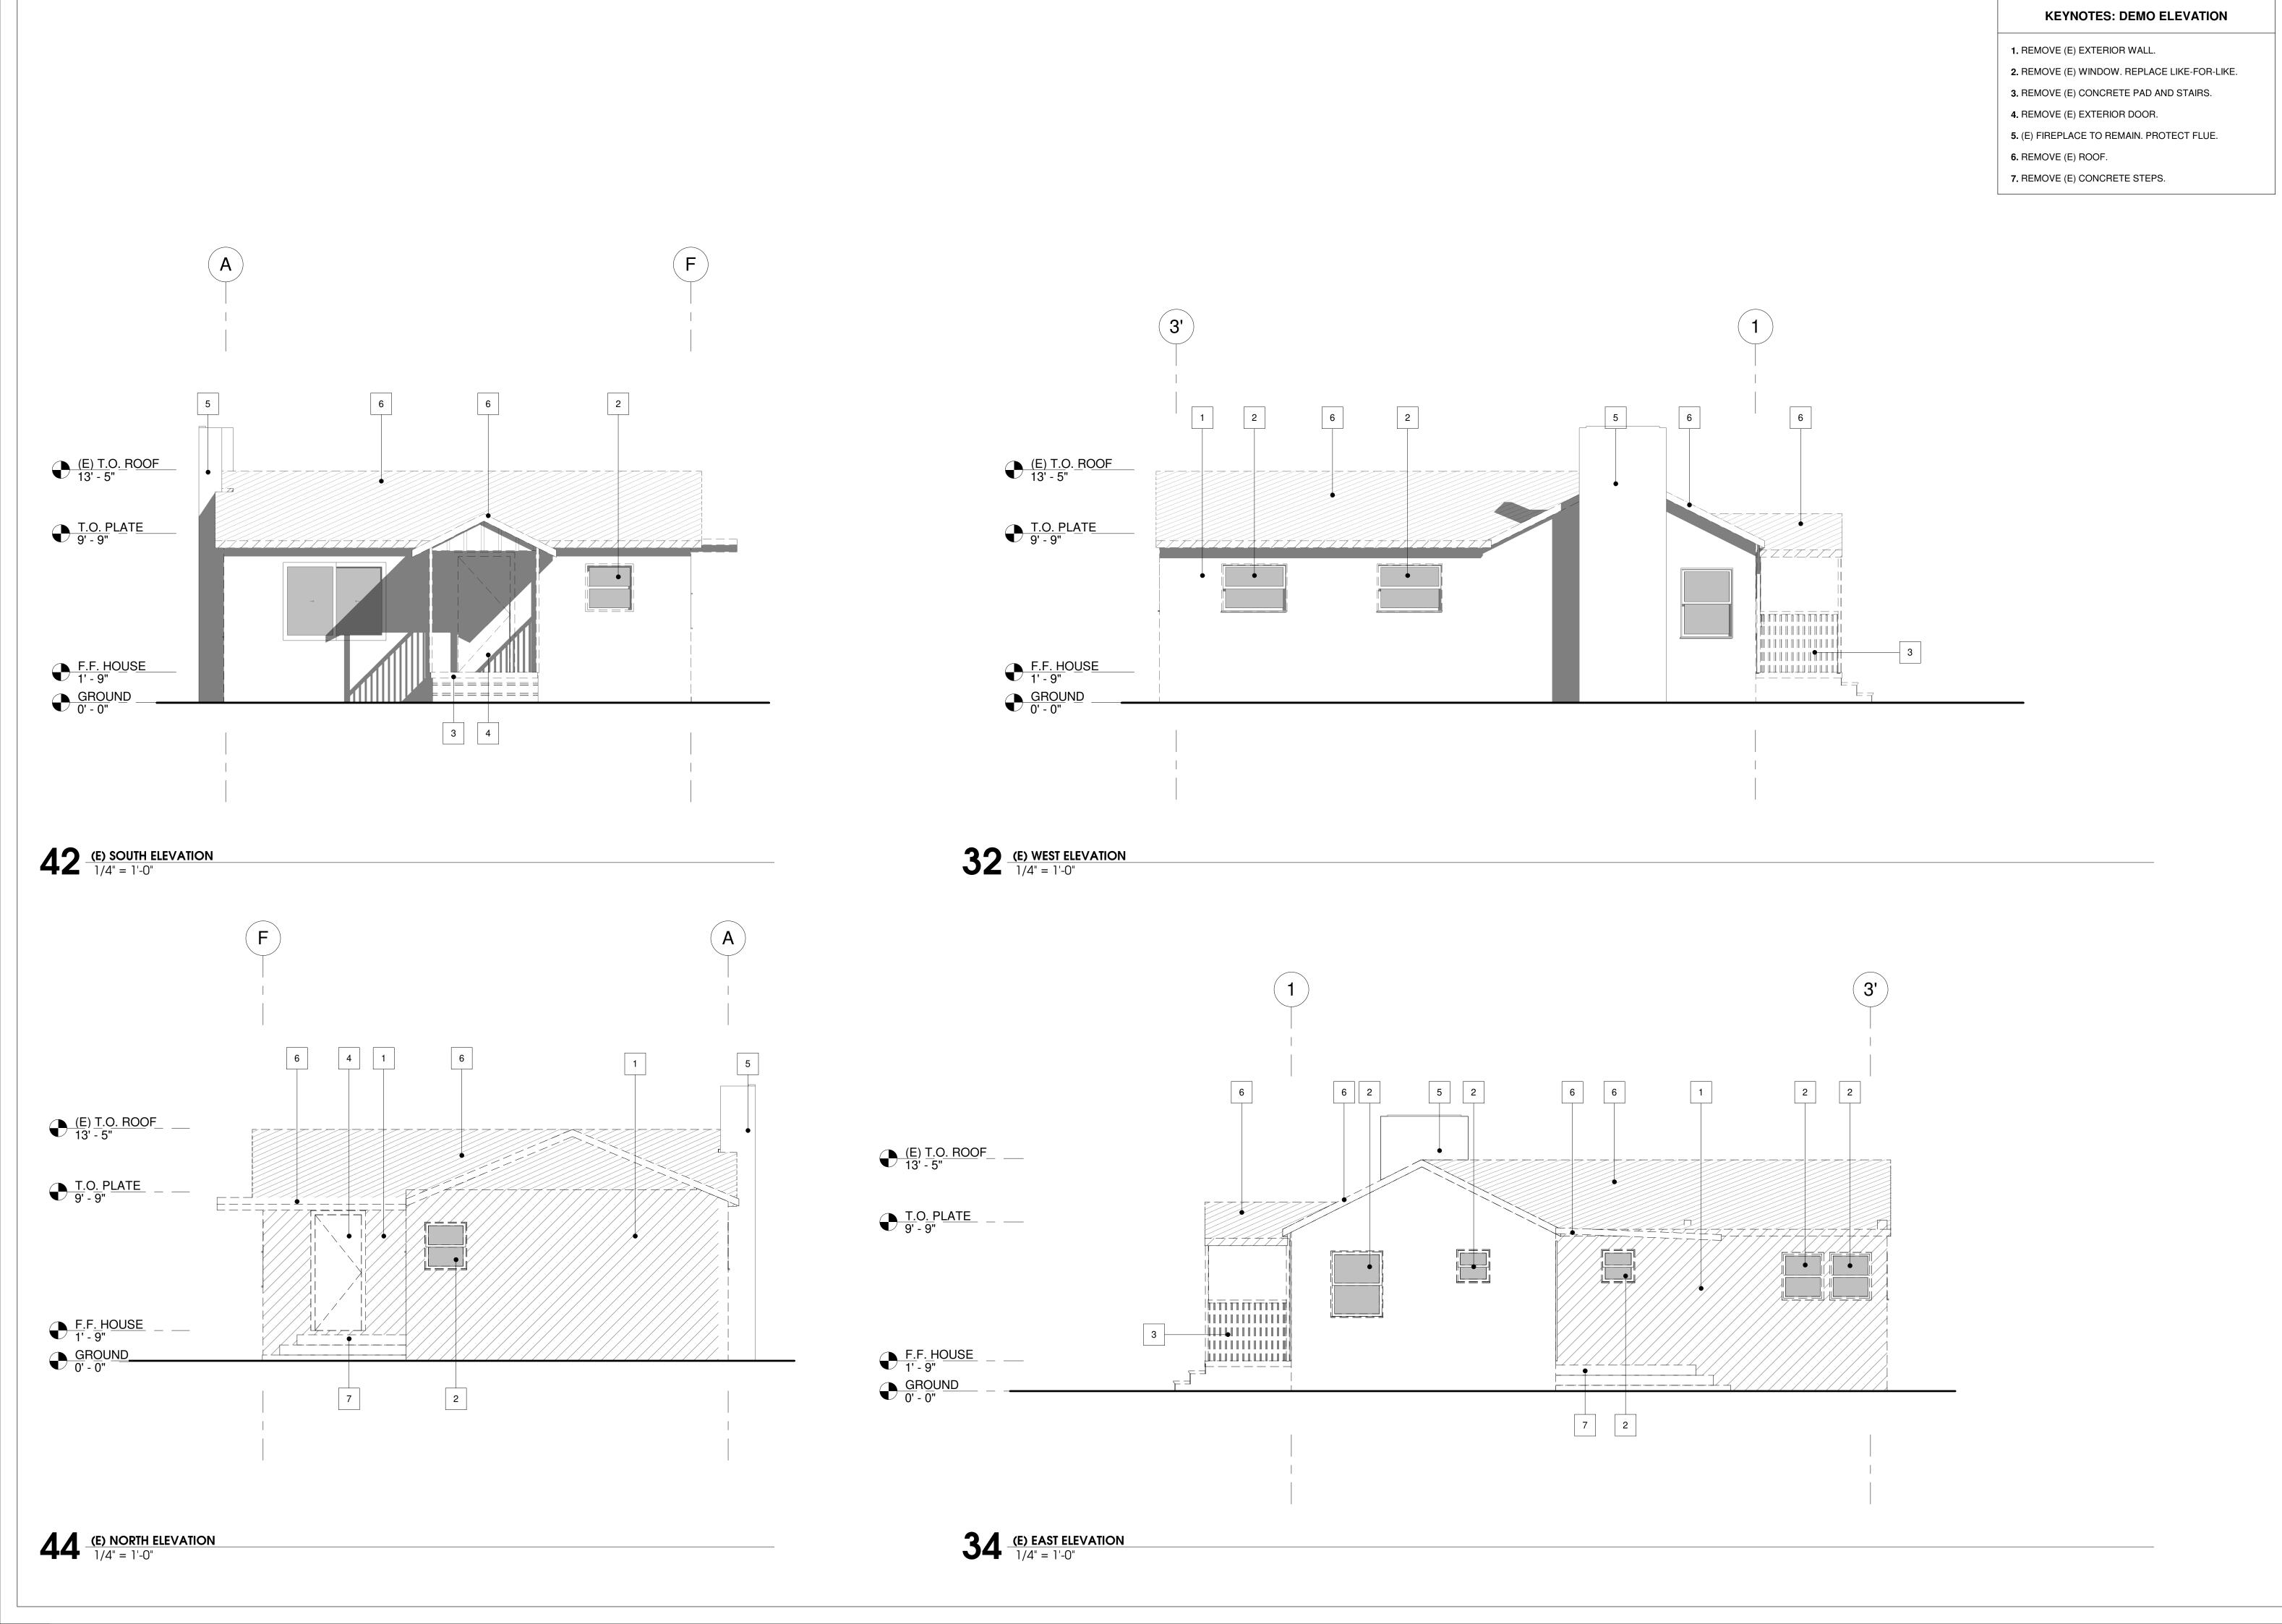



architect: andrew goodwin, aia andrew@andrewgoodwin.us

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REVISIONS

REV # | REV DATE | REV DESCRIPTION

ANDREW C.
GOODWIN

No. C-34213

REN. 10731/2023

PROJECT

BUCKLEY REMODEL 305 SHORT STREET ARROYO GRANDE, CA 93420

APN: 007-544-002 **CLIENT**

RYAN BUCKLEY +
BERENICE
SAINT-SAENS
305 SHORT STREET
ARROYO GRANDE, CA
93420

SHEET TITLE

DEMO ELEVATIONS

11/01/2021


DATE:

TECHNICIAN:

PROJECT MANAGER: BAS

JOB NUMBER:
SHEET NUMBER

A3.1

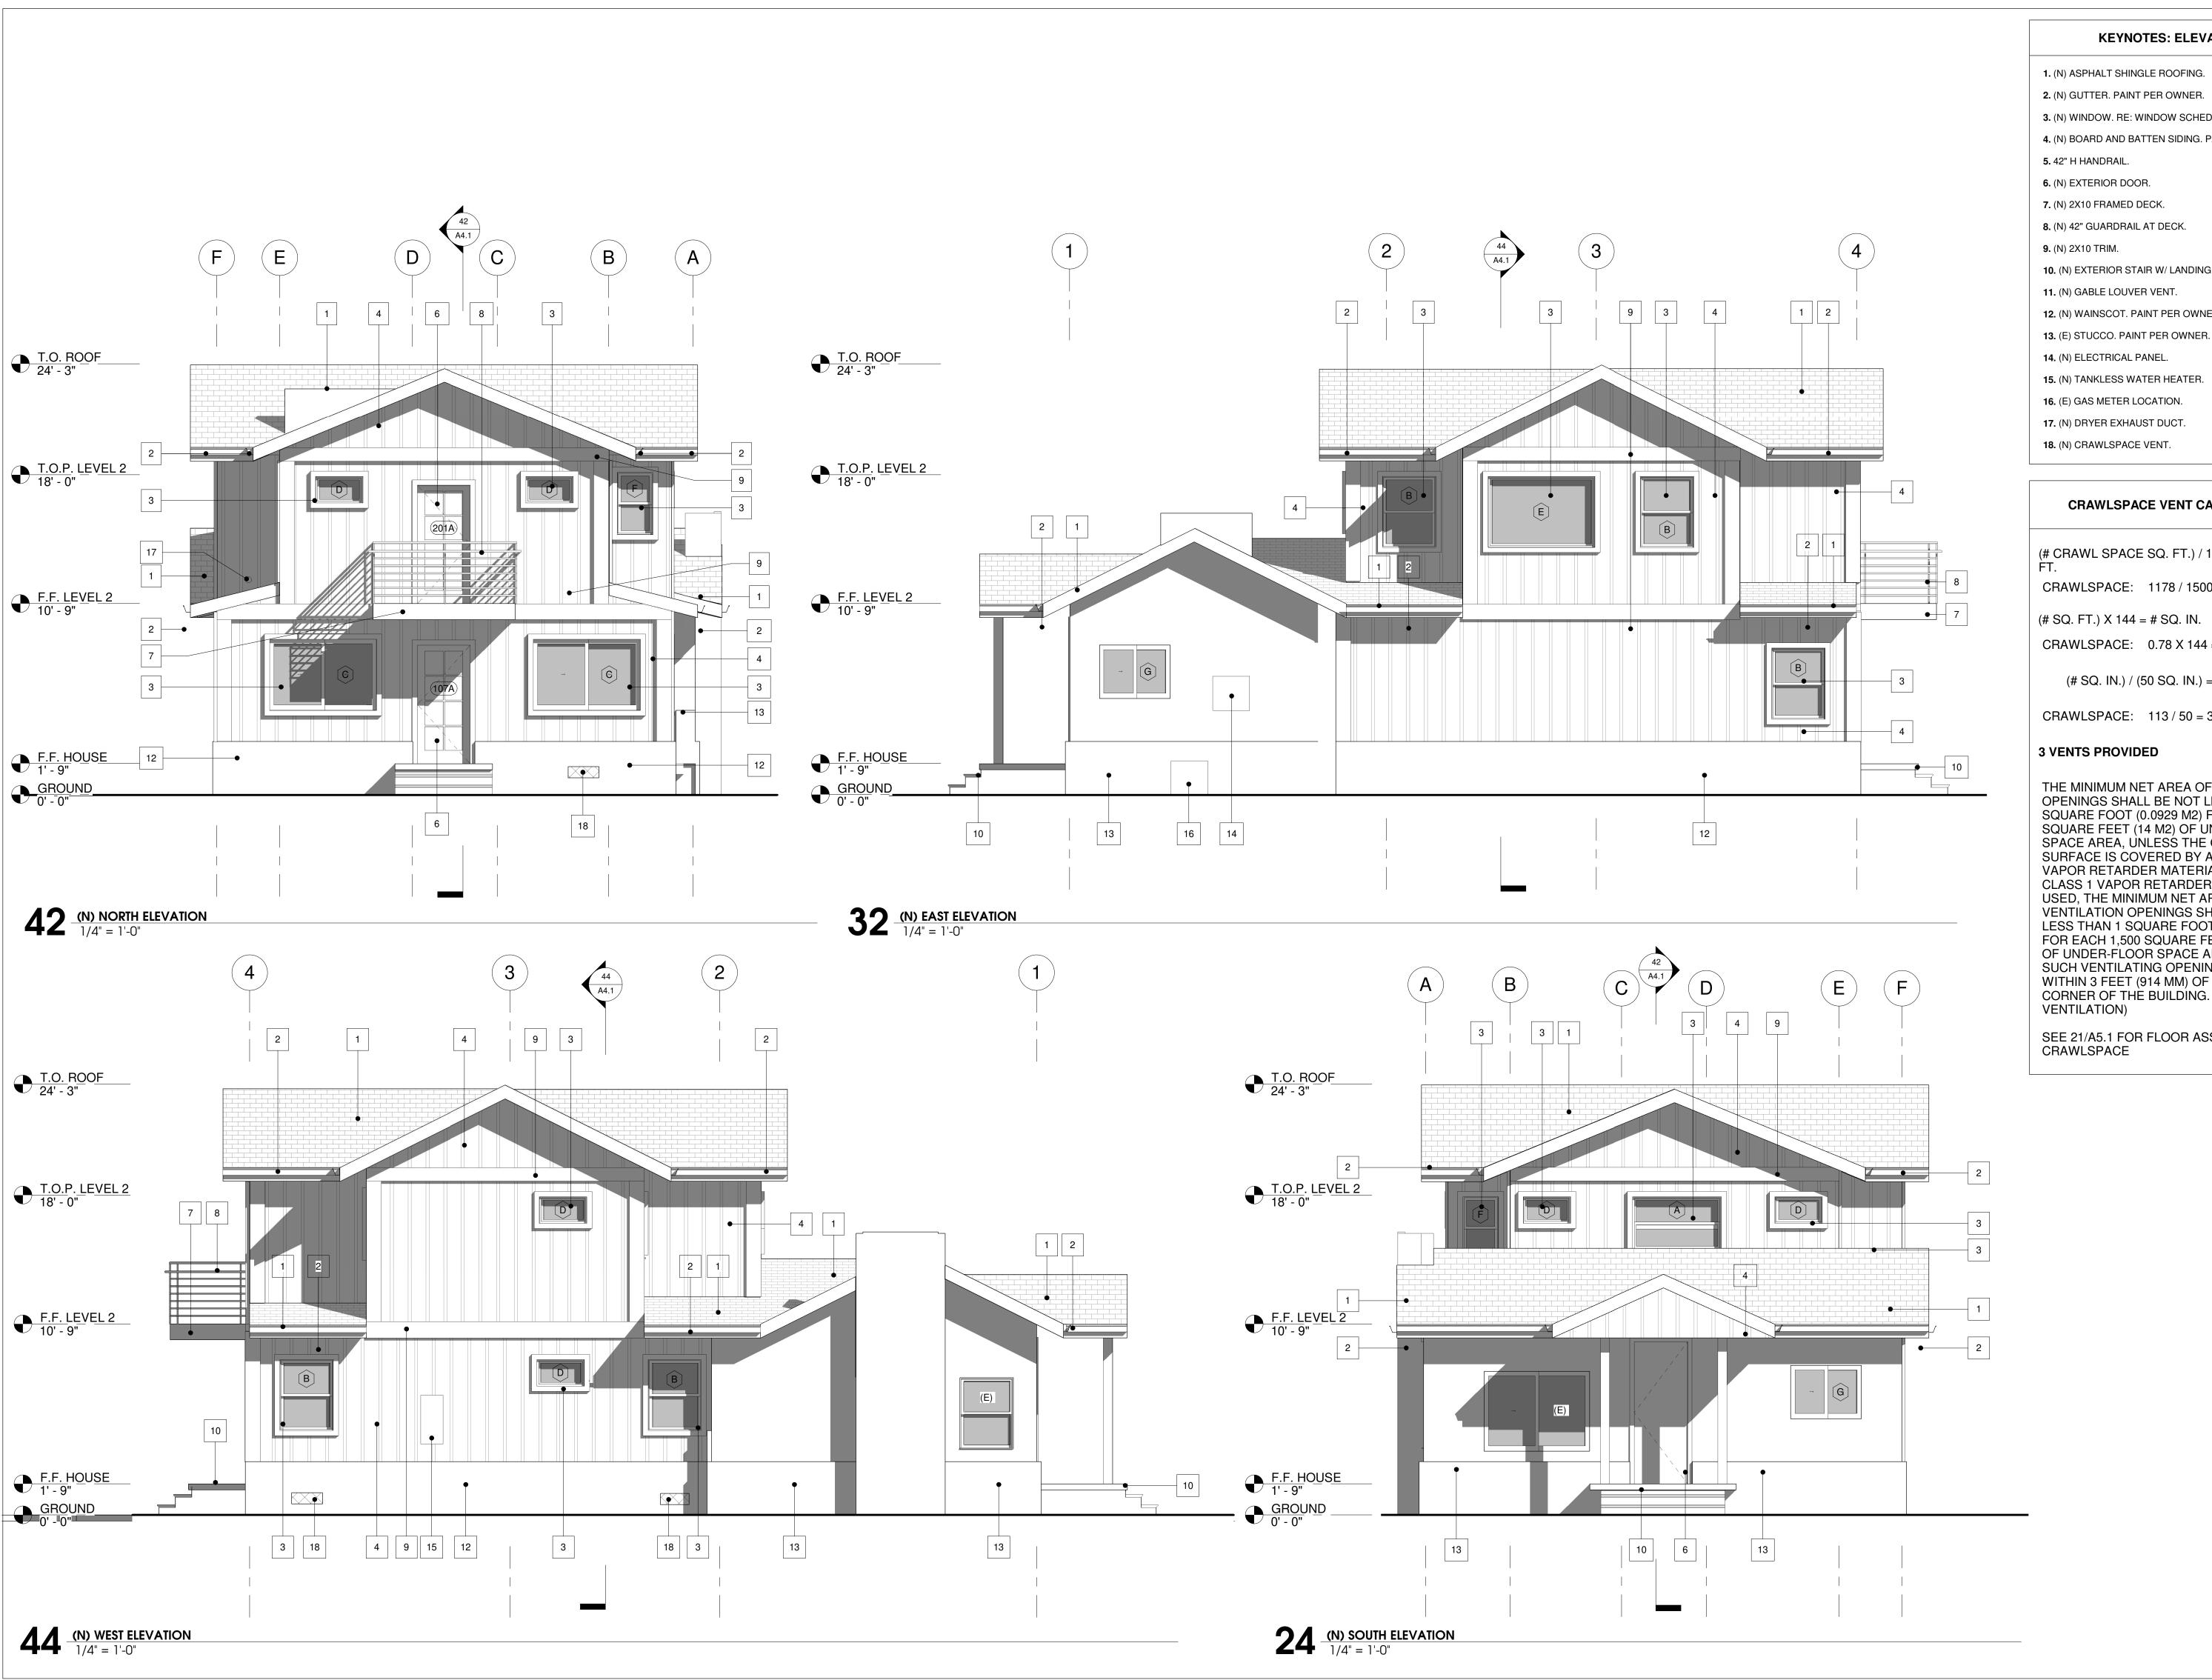

KEYNOTES: ELEVATION

1. (N) ASPHALT SHINGLE ROOFING.

3. (N) WINDOW. RE: WINDOW SCHEDULE.

4. (N) BOARD AND BATTEN SIDING. PAINT PER OWNER.

10. (N) EXTERIOR STAIR W/ LANDING.

11. (N) GABLE LOUVER VENT.

12. (N) WAINSCOT. PAINT PER OWNER.

15. (N) TANKLESS WATER HEATER.

16. (E) GAS METER LOCATION.

17. (N) DRYER EXHAUST DUCT.

18. (N) CRAWLSPACE VENT.

CRAWLSPACE VENT CALCULATION

(# CRAWL SPACE SQ. FT.) / 1500 = # SQ.

CRAWLSPACE: 1178 / 1500 = 0.78 SQ. FT.

(# SQ. FT.) X 144 = # SQ. IN.

CRAWLSPACE: 0.78 X 144 = 113 SQ. IN.

(# SQ. IN.) / (50 SQ. IN.) = CRAWLSPACE

CRAWLSPACE: 113 / 50 = 3 VENTS

3 VENTS PROVIDED

THE MINIMUM NET AREA OF VENTILATION OPENINGS SHALL BE NOT LESS THAN 1 SQUARE FOOT (0.0929 M2) FOR EACH 150 SQUARE FEET (14 M2) OF UNDER-FLOOR SPACE AREA, UNLESS THE GROUND SURFACE IS COVERED BY A CLASS 1 VAPOR RETARDER MATERIAL. WHERE A CLASS 1 VAPOR RETARDER MATERIAL IS USED, THE MINIMUM NET AREA OF VENTILATION OPENINGS SHALL BE NOT LESS THAN 1 SQUARE FOOT (0.0929 M2)
FOR EACH 1,500 SQUARE FEET (140 M2)
OF UNDER-FLOOR SPACE AREA. ONE
SUCH VENTILATING OPENING SHALL BE WITHIN 3 FEET (914 MM) OF EACH CORNER OF THE BUILDING. (R408.1 VENTILATION)

SEE 21/A5.1 FOR FLOOR ASSEMBLY AT CRAWLSPACE

ARCHITECTURE | DESIGN

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> architect: andrew goodwin, aia andrew@andrewgoodwin.us

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1 12/02/2021 PC 1



PROJECT

CLIENT

BUCKLEY REMODEL 305 SHORT STREET ARROYO GRANDE, CA 93420

APN: 007-544-002

RYAN BUCKLEY + BERENICE SAINT-SAENS 305 SHORT STREET ARROYO GRANDE, CA 93420

SHEET TITLE

PROPOSED ELEVATIONS

11/01/2021 DATE:


TECHNICIAN:

JOB NUMBER:

PROJECT MANAGER: BAS

SHEET NUMBER

A3.2

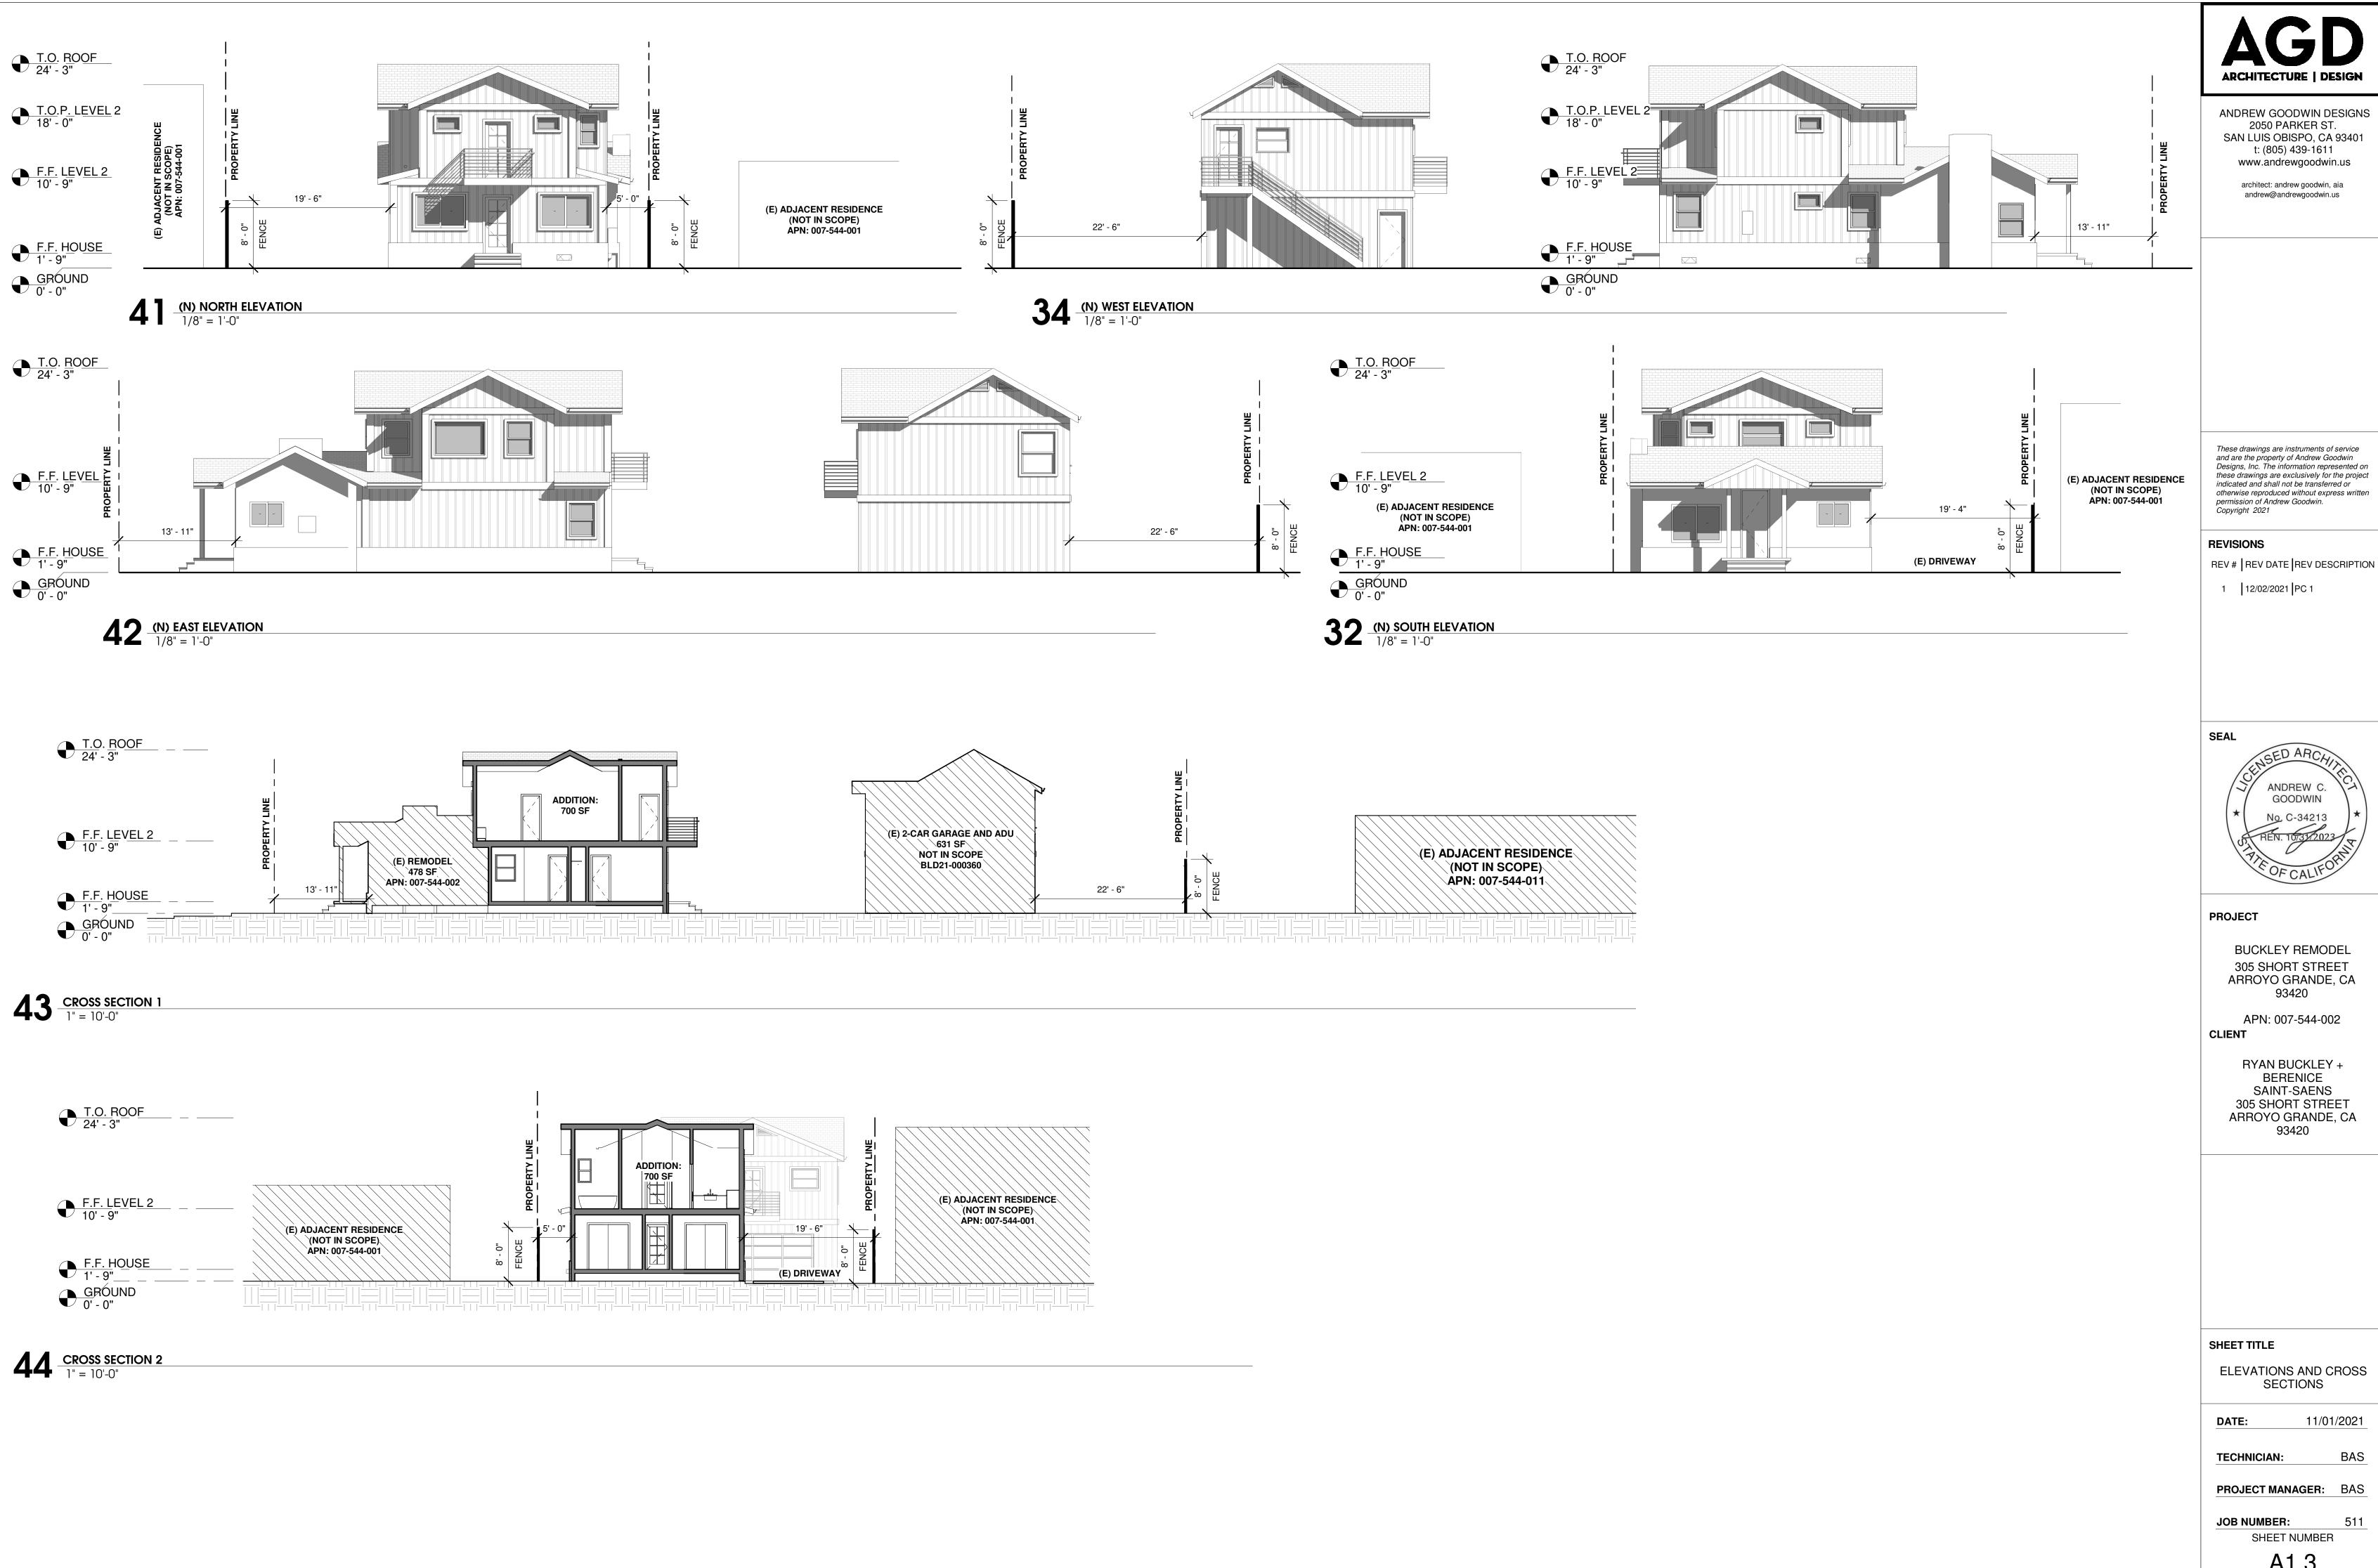

architect: andrew goodwin, aia andrew@andrewgoodwin.us

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BUCKLEY REMODEL 305 SHORT STREET ARROYO GRANDE, CA 93420

APN: 007-544-002


RYAN BUCKLEY + BERENICE SAINT-SAENS 305 SHORT STREET ARROYO GRANDE, CA 93420

ELEVATIONS AND CROSS


BAS

PROJECT MANAGER: BAS

A1.3

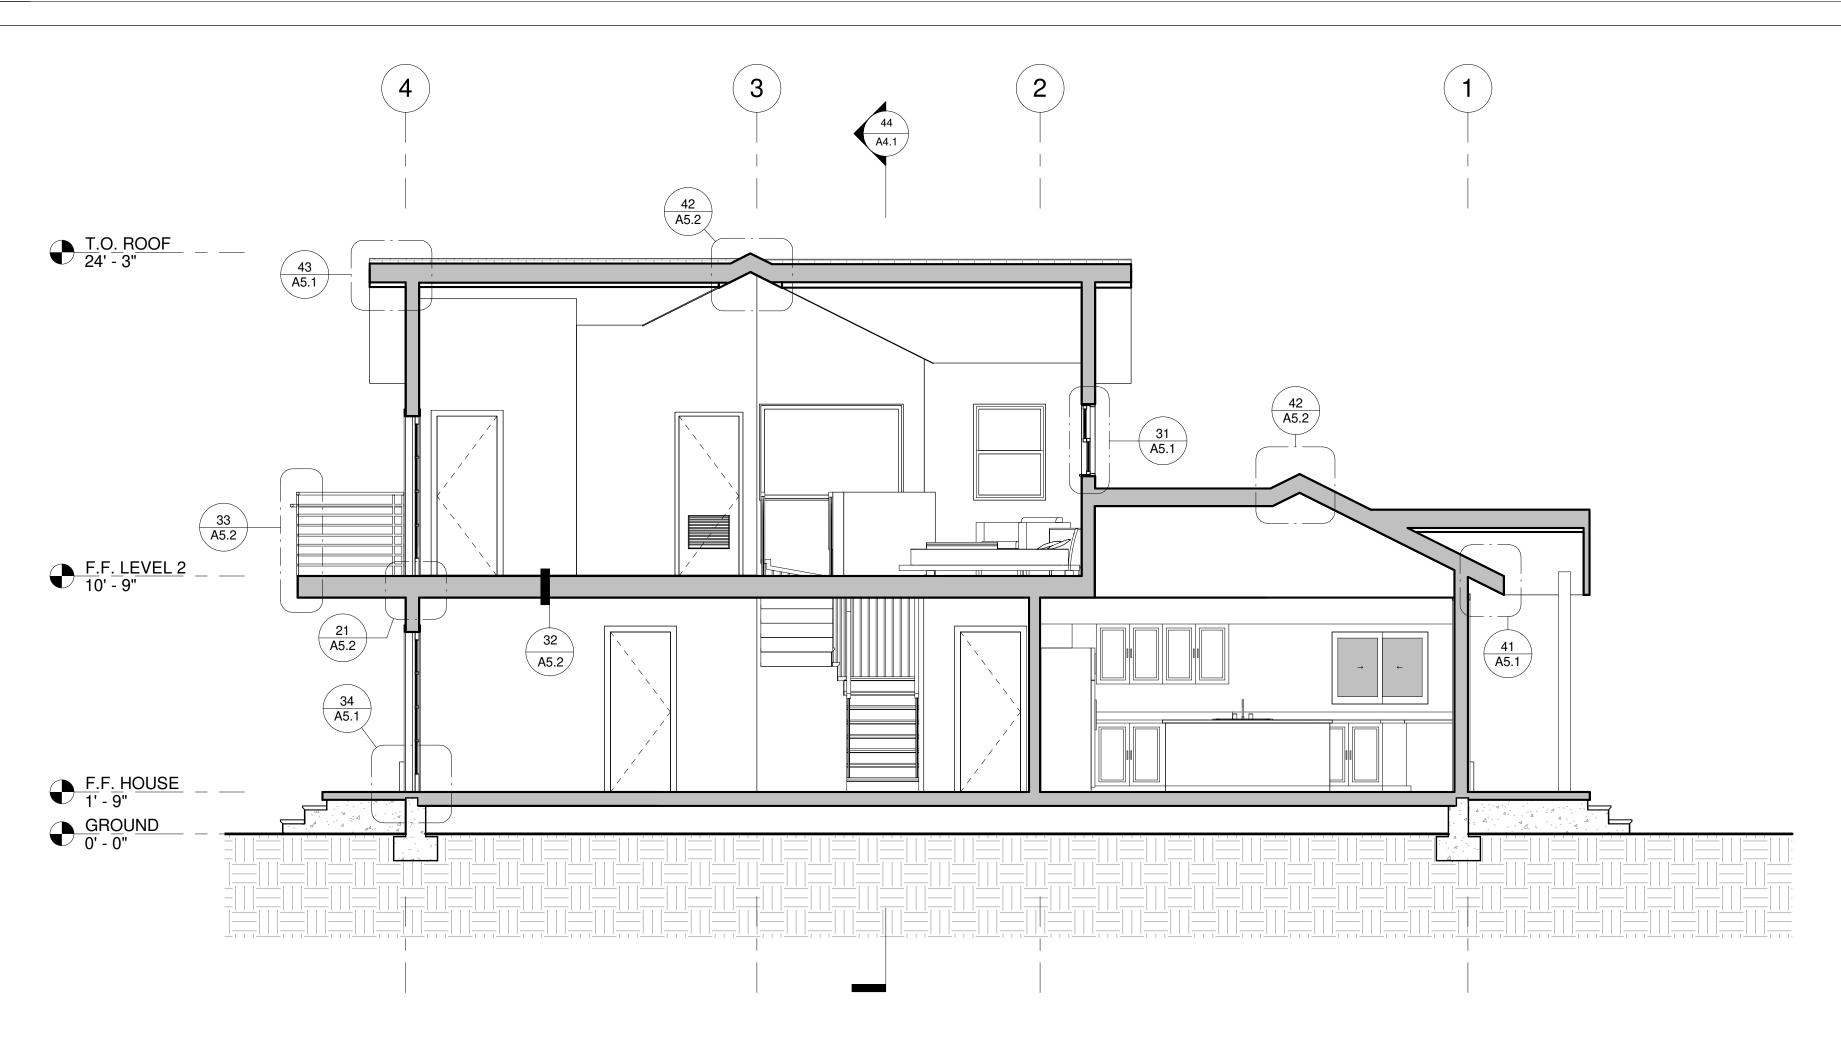

42 <u>SECTION 1</u> 1/4" = 1'-0'

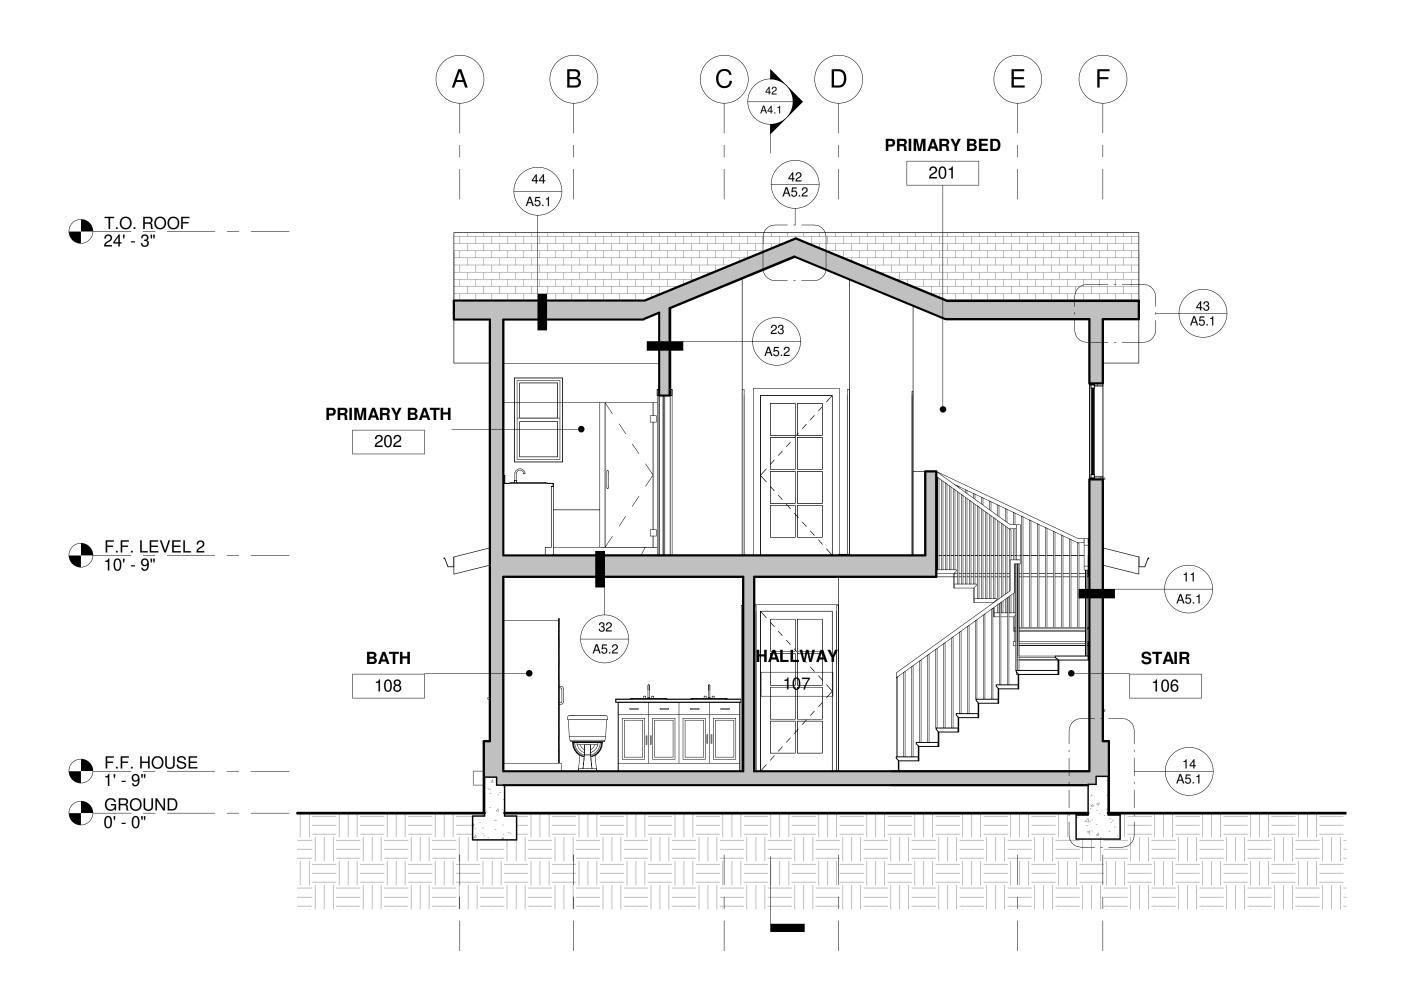

AGD

ARCHITECTURE I DESIGN

ANDREW GOODWIN DESIGNS 2050 PARKER ST. SAN LUIS OBISPO, CA 93401 t: (805) 439-1611 www.andrewgoodwin.us

architect: andrew goodwin, aia andrew@andrewgoodwin.us

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ANDREW C.
GOODWIN

No. C-34213

REN. 10/31/2023

PROJECT

BUCKLEY REMODEL 305 SHORT STREET ARROYO GRANDE, CA 93420

APN: 007-544-002 **CLIENT**

RYAN BUCKLEY +
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ARROYO GRANDE, CA
93420

KEYNOTES: SECTION

1. ROOF ASSEMBLY W/ R-38 BATT INSULATION PER DETAIL 44/A5.1. SEE STRUCTURAL.

2. FLOOR/CEILING FRAMING W/ R-19 INSULATION AND 1 HOUR RATING PER DETAIL 32/A5.2.

3. GYP. BOARD FINISH OF CEILINGS AND INTERIOR WALLS. 5/8" TYPE 'X' THROUGHOUT GARAGE. 5/8" GYP. THROUGHOUT ADU.

4. CABINETS AND BUILT-INS BY CLIENT.

5. SLAB ON GRADE CONCRETE FLOOR IN GARAGE TO SLOPE 1% TOWARDS GARAGE DOOR.

6. INTERIOR WALL W/ GYP. EA. SIDE U.O.N. RE: DETAILS 23/A5.2.

SHEET NUMBER

A4.1

PROJECT MANAGER: BAS

SECTIONS

11/01/2021

BAS

SHEET TITLE

DATE:

TECHNICIAN:

JOB NUMBER:

SECTION 1/4" = 1'-